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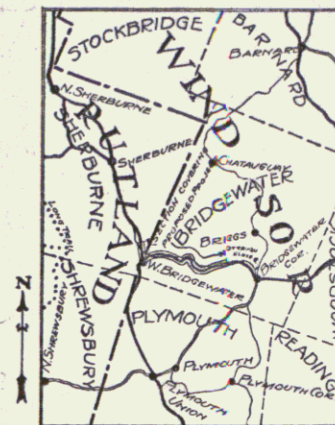
STATE OF VERMONT
STATE HIGHWAY DEPARTMENT

PLAN AND PROFILE OF PROPOSED
STATE HIGHWAY
FLOOD RELIEF PROJECT

TOWNS OF SHERBURNE - BRIDGEWATER
BRIDGEWATER - RUTLAND ROAD

Pin # 99R181


| FED. ROAD DIST. NO. | STATE | FED. AID PROJ. NO. | FISCAL YEAR | SHEET NO. | TOTAL SHEETS |
|---------------------|-------|--------------------|-------------|-----------|--------------|
| 9 | Vt. | FRSD | 1926 | 1 | 48 |



-SCALE-
1 INCH = 4 MILES

FROM THE FIRST STEEL BRIDGE WEST OF THE SHERBURNE-BRIDGEWATER TOWN LINE EASTERLY TO THE FIRST STEEL BRIDGE WEST OF BRIDGEWATER CORNERS.

LENGTH OF PROJECT INCLUDING BRIDGES OVER 20 FT. SPAN = 5932.48 FT. = 11.23 MILES
LENGTH OF PROJECT EXCLUDING BRIDGES OVER 20 FT. SPAN = 5496.25 FT. = 10.40 MILES

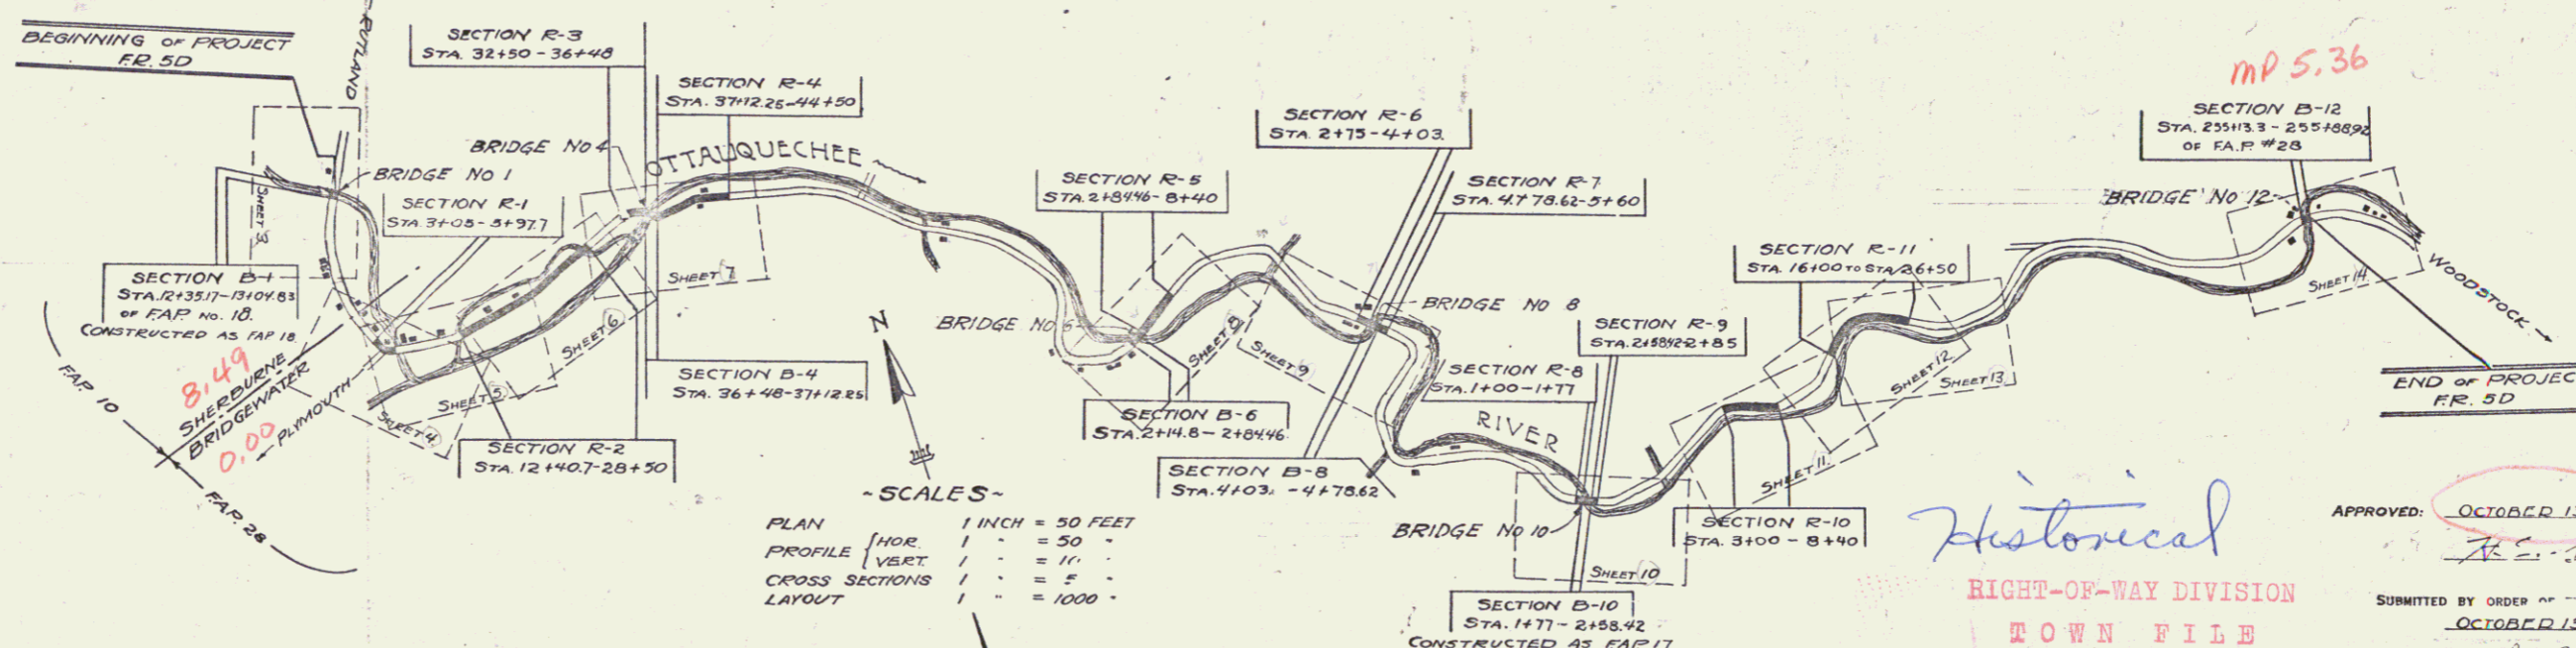

-SCALES-
PLAN 1 INCH = 50 FEET
PROFILE HOR. 1" = 50'
VERT. 1" = 10'
CROSS SECTIONS 1" = 5'
LAYOUT 1" = 1000'

Sherburne
Bridge Water
5D

| CONVENTIONAL SIGNS | |
|--------------------|------------------|
| COUNTY LINE | GROUND ELEVATION |
| TOWN LINE | GRADE ELEVATION |
| FENCE LINE | |
| STONE WALL | |
| UNFENCED PROPERTY | |
| GUARD RAIL | |
| TRAVELED WAY | |
| RAILROAD | |
| RETAINING WALL | |
| CENTER LINE | |
| SURVEY LINE | |
| CULVERT | |
| DROP INLET | |
| TROLLEY POLE | |
| POWER POLE | |
| TELEPHONE POLE | |
| TREES | |
| HEDGE | |

THE NUMBERS OF THE BRIDGES AS CONSTRUCTED AS PARTS OF FAP 10, 17, 18, & 28 ARE DESIGNATED AS B-1, B-4, ETC. OF PROJECT FR 3D, THE NUMBERS BEING THE SAME AS THE RESPECTIVE NUMBERS OF THE BRIDGES ON THE OLD PROJECTS

SOME CONSTRUCTION WORK HAS BEEN DONE ON THIS PROJECT SINCE THE SURVEY WAS MADE; THEREFORE THE EARTHWORK & BRIDGE QUANTITIES GIVEN ARE ONLY APPROXIMATE.

THIS PROJECT TO BE CONSTRUCTED IN ACCORDANCE WITH STANDARD SPECIFICATIONS ON FILE WITH THE U.S. BUREAU OF PUBLIC ROADS AS APPROVED JULY 7, 1926.

THESE PLANS SUBJECT TO SUCH REVISIONS AS MAY BE REQUIRED BY THE BUREAU OF PUBLIC ROADS OR THE CHIEF ENGINEER.

APPROVED: OCTOBER 13, 1926
Historical
RIGHT-OF-WAY DIVISION
TOWN FILE
PERPETUAL
Town of VS4
(To Be Returned To R.O.W. Division)

RECOMMENDED
DISTRICT ENGINEER
BUREAU OF PUBLIC ROADS
RECOMMENDED FOR APPROVAL
CHIEF ENGINEER
BUREAU OF PUBLIC ROADS
APPROVED
DIRECTOR - BUREAU OF PUBLIC ROADS
project No. FR 5D
SERIES F.R. No. 5D FILED
SHEET 1 OF 48