


- Soil Limit
- Ordinary High Water
- 50' Riparian Corridor
- Wetland Limit
- 50' Wetland Buffer Limit
- R.O.W. & Property Lines
- Sensitive Area (SA)

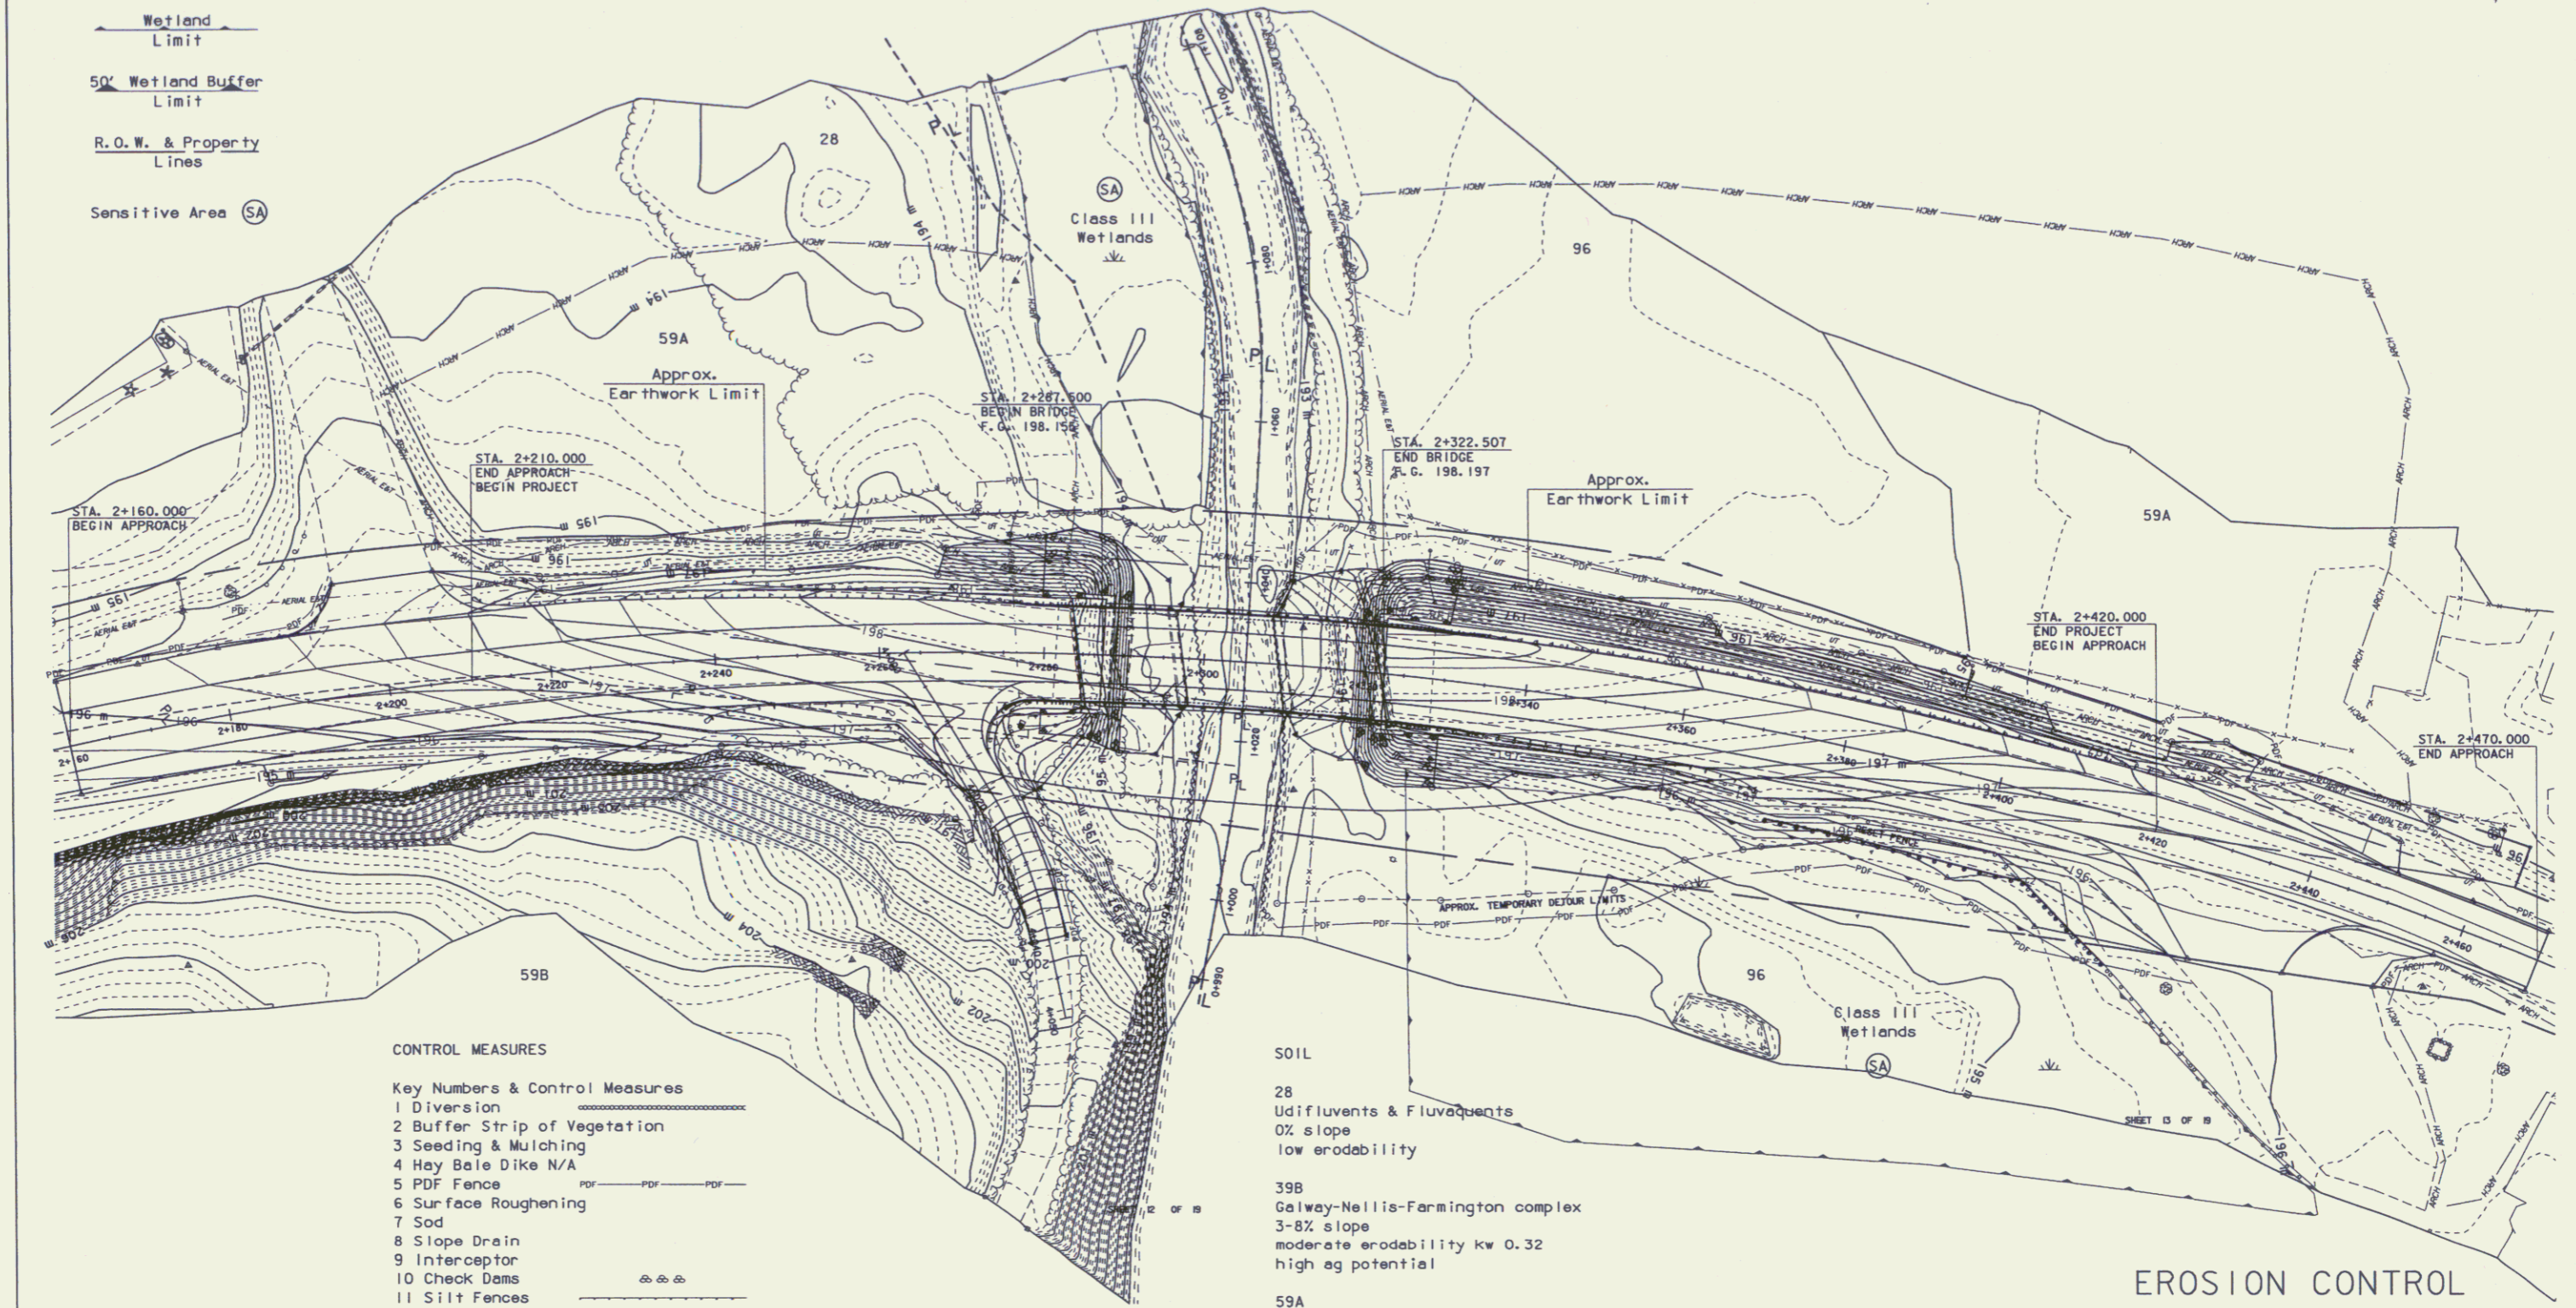


**CONTROL MEASURES**

- Key Numbers & Control Measures
- 1 Diversion
  - 2 Buffer Strip of Vegetation
  - 3 Seeding & Mulching
  - 4 Hay Bale Dike N/A
  - 5 PDF Fence
  - 6 Surface Roughening
  - 7 Sod
  - 8 Slope Drain
  - 9 Interceptor
  - 10 Check Dams
  - 11 Silt Fences
  - 12 Sediment Basin
  - 13 Sediment Trap
  - 14 Perimeter Diversion
  - 15 Stabilized Construction Entrance
  - 16 Erosion Matting
  - 17 Inlet Protection
  - 18 Filter Curtain
  - 19 Geotextile Under Stone Fill
  - 20 Stone Fill

**SOIL**

- 28 Udifluents & Fluvaquents  
0% slope  
low erodability
- 39B Galway-Nellis-Farmington complex  
3-8% slope  
moderate erodability kw 0.32  
high ag potential
- 59A Deerfield loamy sand  
0-4% slope  
low erodability kw 0.17  
good ag potential
- 96 Udipsamments  
0% slope  
low erodability

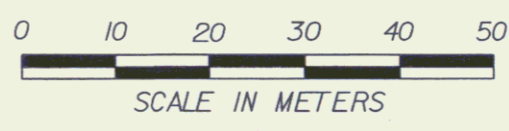

SCALE 1:400

**EROSION CONTROL  
FINAL GRADING PLAN  
FINAL EP&SC PLAN**

DATUM SHEET 1 OF 19  
VERTICAL NAVD 88 GPS  
HORIZONTAL NAVD 83/92 GPS

PROJECT: RUTLAND TOWN	PROJECT NO.: BRF 019-3(48)
DESIGN FILE NAME: 95b172/structures/sb172ero.dgn	PLOT DATE: 17-SEP-2004
IPARM FILE NAME: sb172er2.1	SURVEY DATE:
SURVEYED BY:	DRAWN BY: T LACKEY
SQUAD LEADER: R WHITCOMB	SHEET 10 OF 19

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