

**LEGEND**

- WOVEN WIRE REINFORCED SILT FENCE
- LIMITS OF SOIL DISTURBANCE
- EROSION MATTING
- PROJECT DEMARCATION FENCE
- RIPARIAN BUFFER ZONE
- STABILIZED CONSTRUCTION ENTRANCE
- APPROXIMATE SOIL BOUNDARY
- HISTORICAL AND ARCHEOLOGICAL AREA


**SOIL CLASSIFICATION**

BERKSHIRE AND MARLOW  
EXTREMELY STONY LOAM (Bsc)  
3% TO 20% SLOPES  
"K FACTOR" = 0.20  
CLASSIFIED LOW EROSION POTENTIAL

COLTON GRAVELLY SANDY LOAM (CtA)  
0% TO 5% SLOPES  
"K FACTOR" = 0.20  
CLASSIFIED LOW EROSION POTENTIAL

COLTON GRAVELLY SANDY LOAM (CtE)  
30% TO 50% SLOPES  
"K FACTOR" = 0.20  
CLASSIFIED LOW EROSION POTENTIAL

STETSON GRAVELLY FINE SANDY LOAM (StA)  
0% TO 5% SLOPES  
"K FACTOR" = 0.10  
CLASSIFIED LOW EROSION POTENTIAL

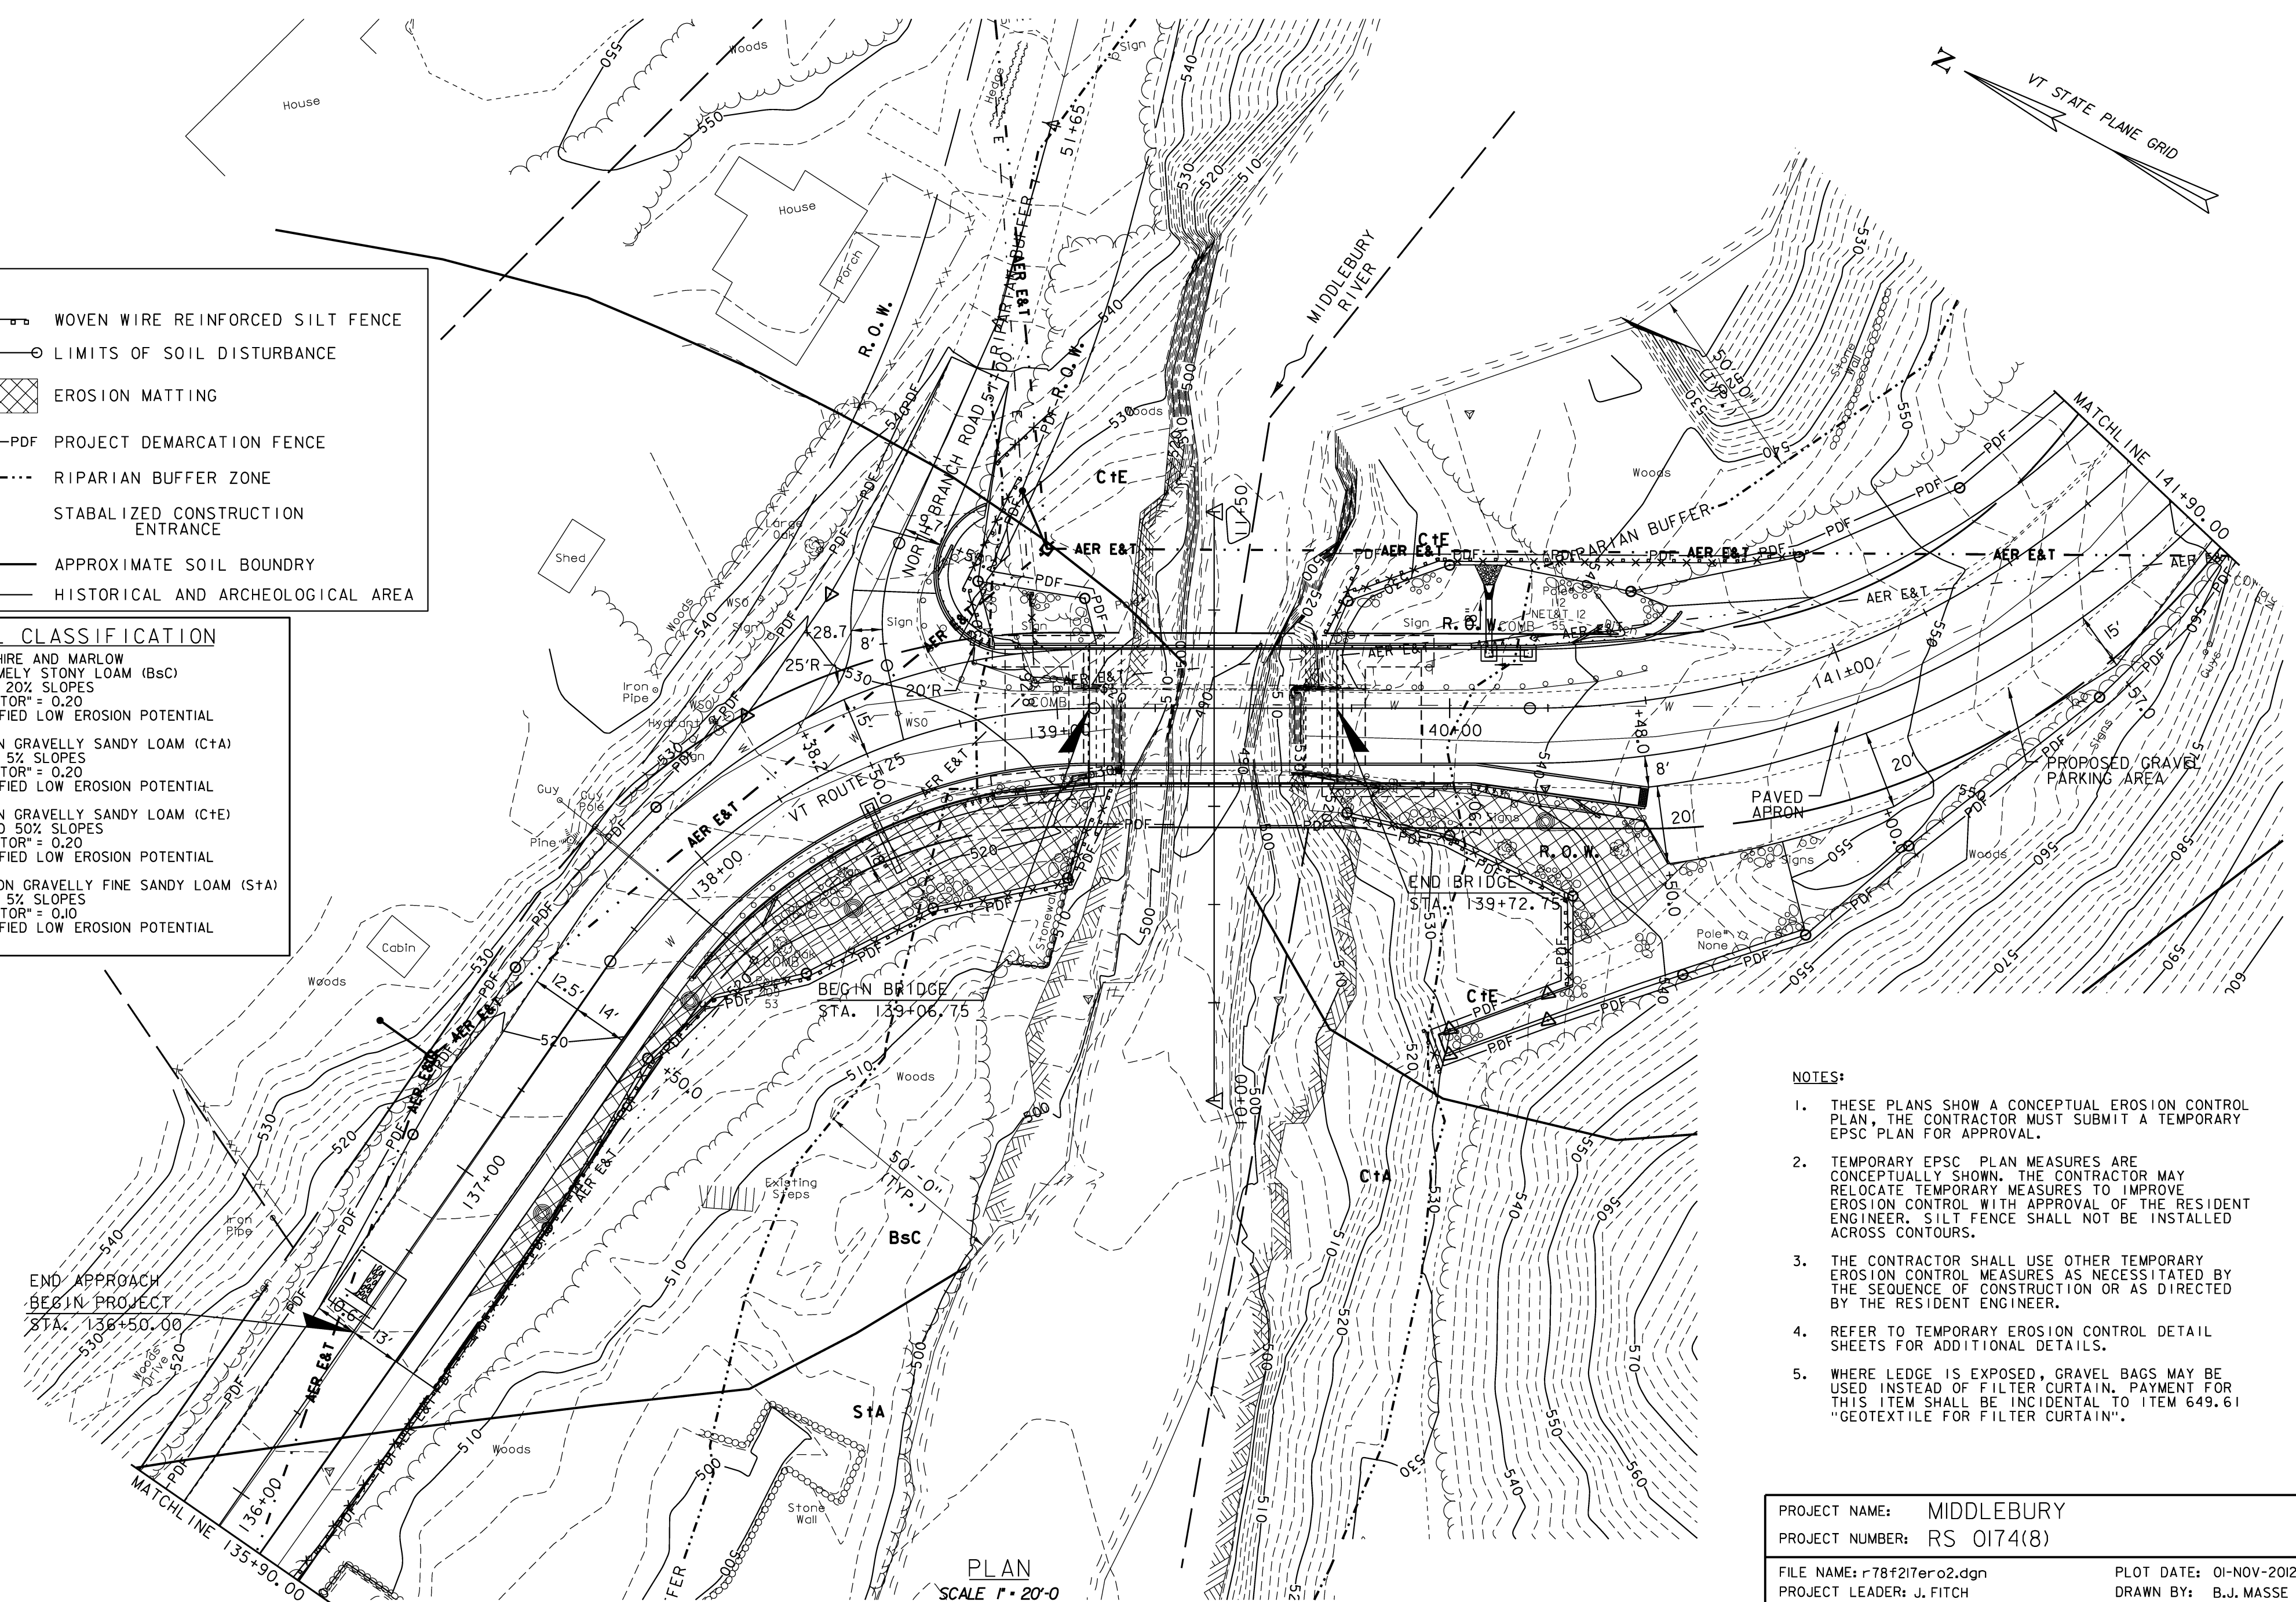

- NOTES:**
- THESE PLANS SHOW A CONCEPTUAL EROSION CONTROL PLAN. THE CONTRACTOR MUST SUBMIT A TEMPORARY EPSC PLAN FOR APPROVAL.
  - TEMPORARY EPSC PLAN MEASURES ARE CONCEPTUALLY SHOWN. THE CONTRACTOR MAY RELOCATE TEMPORARY MEASURES TO IMPROVE EROSION CONTROL WITH APPROVAL OF THE RESIDENT ENGINEER. SILT FENCE SHALL NOT BE INSTALLED ACROSS CONTOURS.
  - THE CONTRACTOR SHALL USE OTHER TEMPORARY EROSION CONTROL MEASURES AS NECESSITATED BY THE SEQUENCE OF CONSTRUCTION OR AS DIRECTED BY THE RESIDENT ENGINEER.
  - REFER TO TEMPORARY EROSION CONTROL DETAIL SHEETS FOR ADDITIONAL DETAILS.
  - WHERE LEDGE IS EXPOSED, GRAVEL BAGS MAY BE USED INSTEAD OF FILTER CURTAIN. PAYMENT FOR THIS ITEM SHALL BE INCIDENTAL TO ITEM 649.61 "GEOTEXTILE FOR FILTER CURTAIN".

PROJECT NAME:	MIDDLEBURY
PROJECT NUMBER:	RS 0174(8)
FILE NAME:	r78f217ero2.dgn
PROJECT LEADER:	J. FITCH
DESIGNED BY:	B.J. MASSE
EPSC CONSTRUCTION SITE PLAN 2 OF 3	
PLOT DATE:	01-NOV-2012
DRAWN BY:	B.J. MASSE
CHECKED BY:	K. REINHART
SHEET	19 OF 21

PLAN  
SCALE 1" = 20'-0"  
20 0 20