


SOIL CLASSIFICATION

BERKSHIRE AND MARLOW
EXTREMELY STONY LOAM (Bsc)
3% TO 20% SLOPES
"K FACTOR" = 0.20
CLASSIFIED LOW EROSION POTENTIAL

STETSON GRAVELLY FINE SANDY LOAM (StA)
0% TO 5% SLOPES
"K FACTOR" = 0.10
CLASSIFIED LOW EROSION POTENTIAL

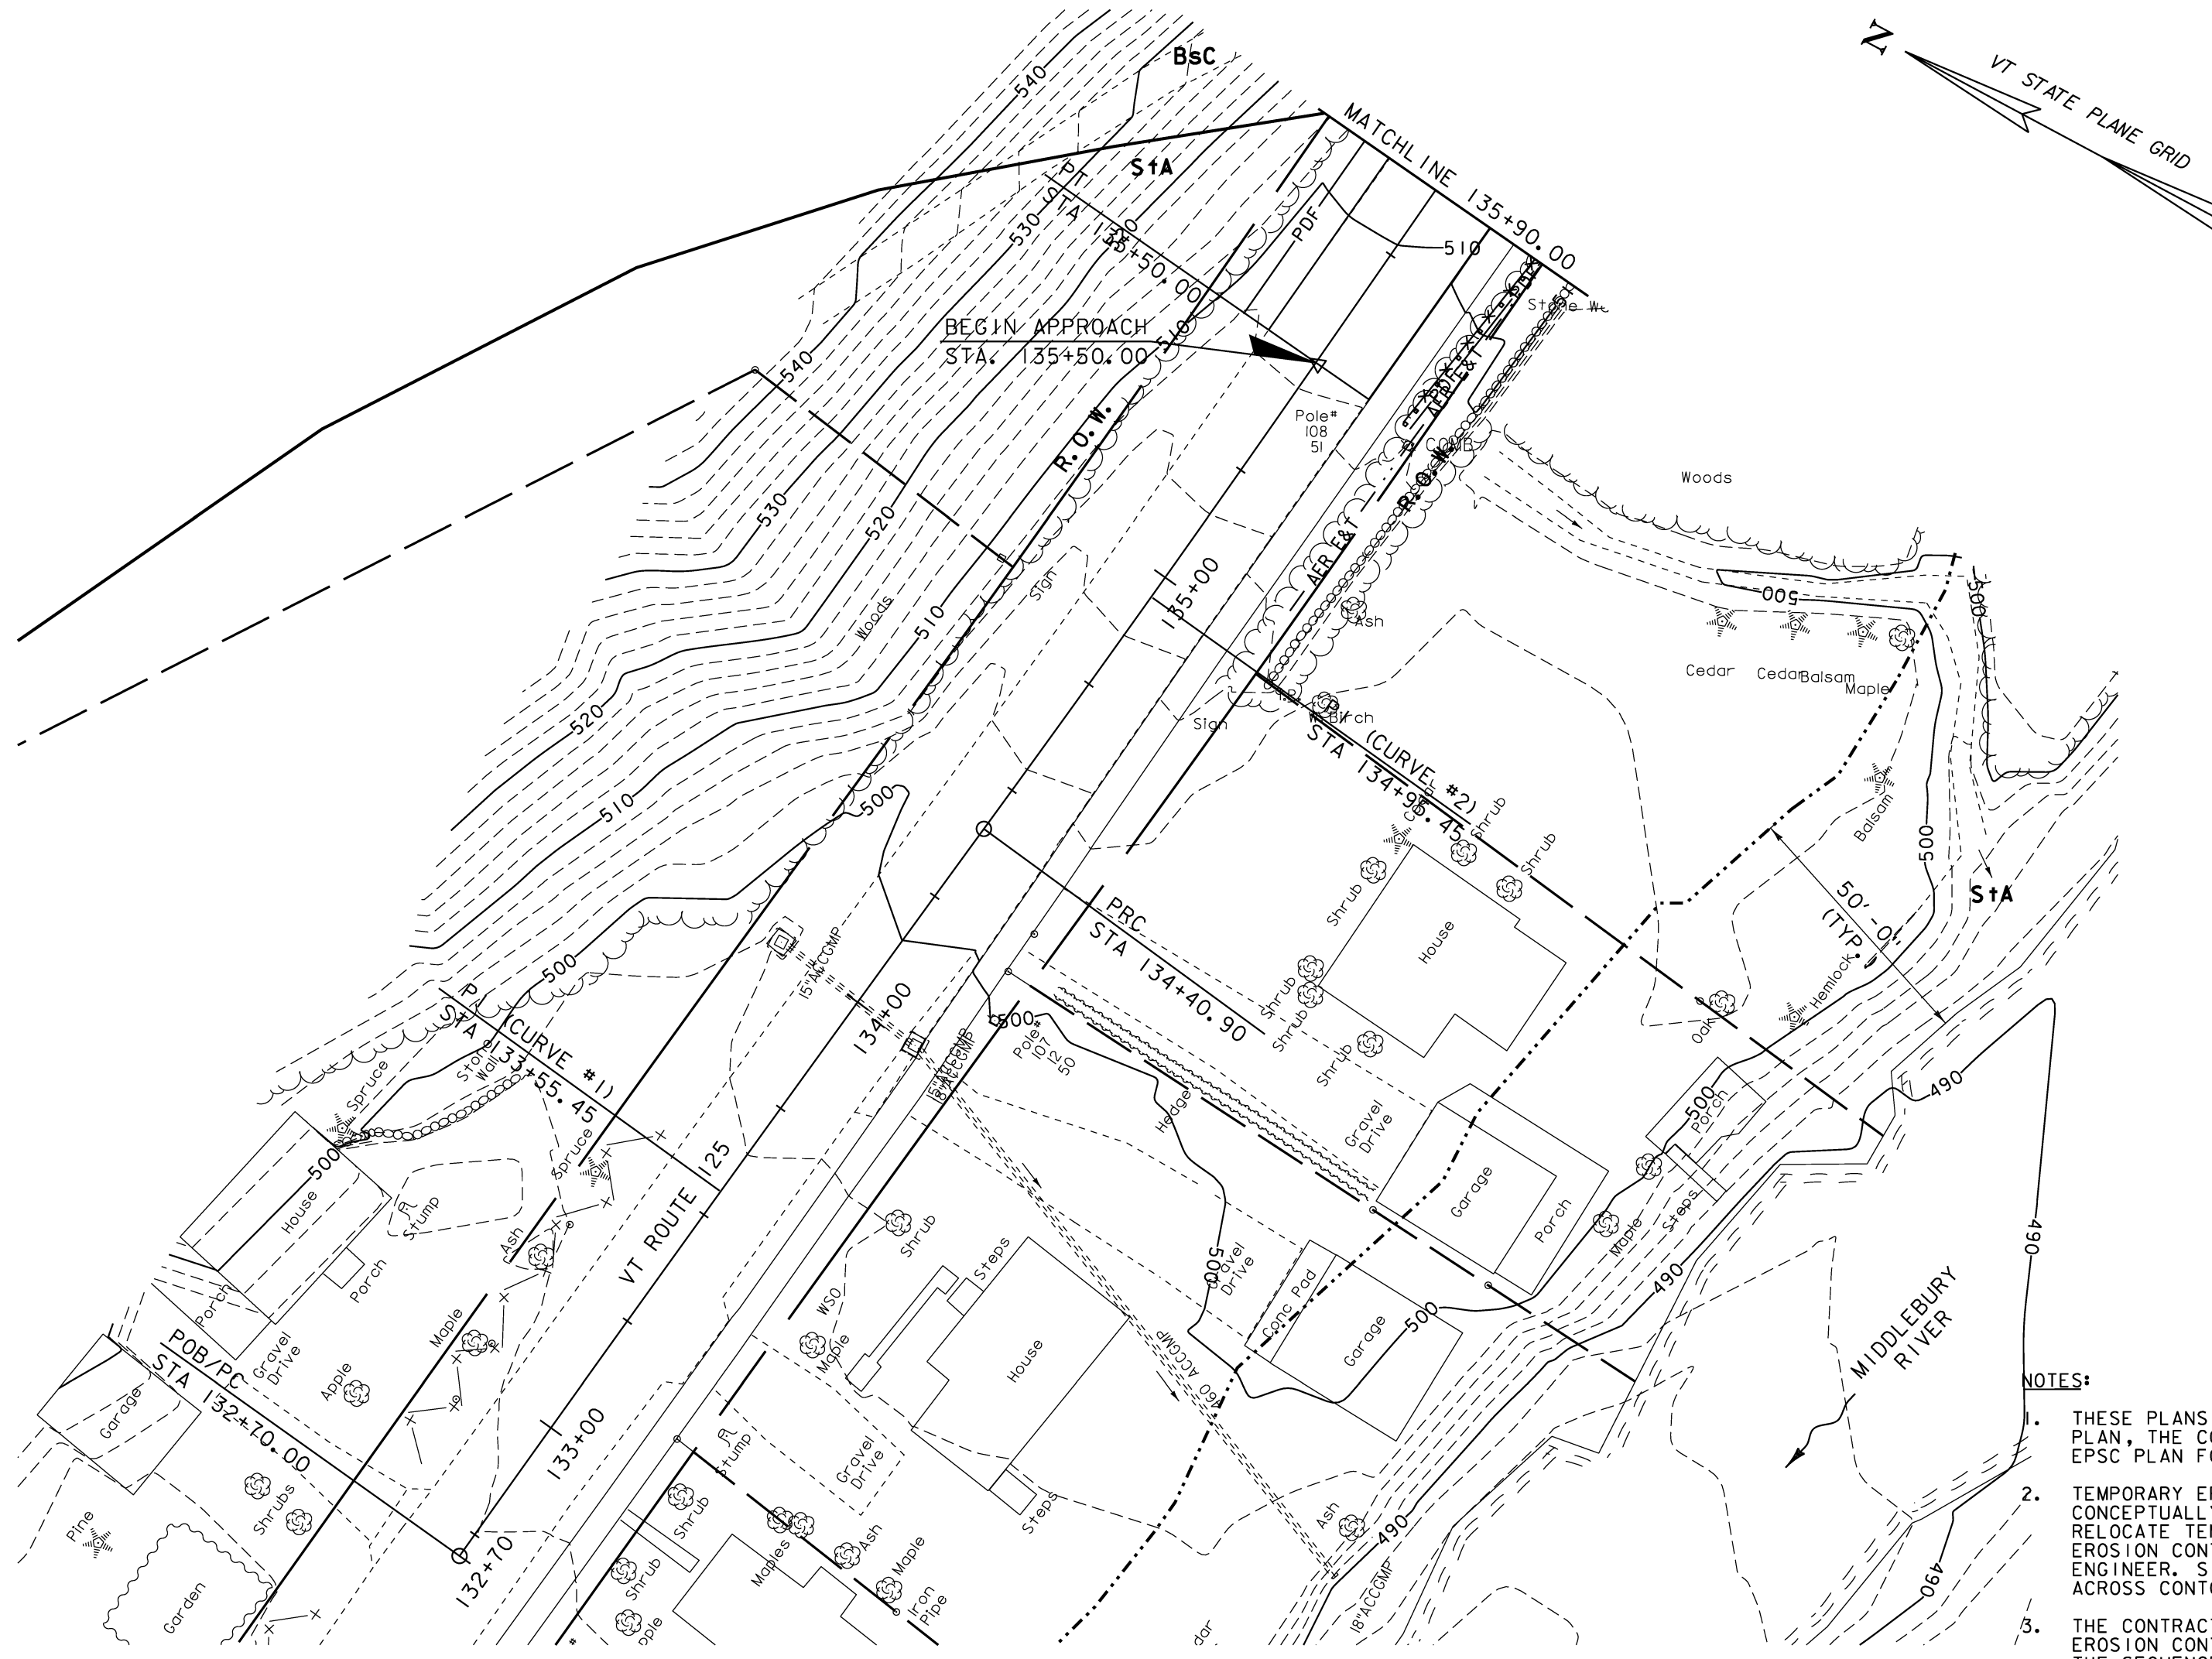

LEGEND

	WOVEN WIRE REINFORCED SILT FENCE
	LIMITS OF SOIL DISTURBANCE
	PDF PROJECT DEMARCATION FENCE
	RIPARIAN BUFFER ZONE
	APPROXIMATE SOIL BOUNDARY
	HISTORICAL AND ARCHEOLOGICAL AREA

PLAN
SCALE 1" = 20'-0"

- NOTES:**
1. THESE PLANS SHOW A CONCEPTUAL EROSION CONTROL PLAN, THE CONTRACTOR MUST SUBMIT A TEMPORARY EPSC PLAN FOR APPROVAL.
 2. TEMPORARY EPSC PLAN MEASURES ARE CONCEPTUALLY SHOWN. THE CONTRACTOR MAY RELOCATE TEMPORARY MEASURES TO IMPROVE EROSION CONTROL WITH APPROVAL OF THE RESIDENT ENGINEER. SILT FENCE SHALL NOT BE INSTALLED ACROSS CONTOURS.
 3. THE CONTRACTOR SHALL USE OTHER TEMPORARY EROSION CONTROL MEASURES AS NECESSITATED BY THE SEQUENCE OF CONSTRUCTION OR AS DIRECTED BY THE RESIDENT ENGINEER.
 4. REFER TO TEMPORARY EROSION CONTROL DETAIL SHEETS FOR ADDITIONAL DETAILS.
 5. WHERE LEDGE IS EXPOSED, GRAVEL BAGS MAY BE USED INSTEAD OF FILTER CURTAIN. PAYMENT FOR THIS ITEM SHALL BE INCIDENTAL TO ITEM 649.61 "GEOTEXTILE FOR FILTER CURTAIN".

PROJECT NAME: MIDDLEBURY	PLOT DATE: 01-NOV-2012
PROJECT NUMBER: RS 0174(8)	DRAWN BY: B.J. MASSE
FILE NAME: r78f217erol.dgn	CHECKED BY: K. REINHART
PROJECT LEADER: J. FITCH	SHEET 18 OF 21
DESIGNED BY: B.J. MASSE	
EPSC CONSTRUCTION SITE PLAN 1 OF 3	