


\* DENOTES PRECAST REINFORCED CONCRETE DROP INLET

NOTE: SEE PIPE PROFILE SHEET 1 AND SHEET 2 INCLUDING MAINLINE CROSS SECTIONS FOR ADDITIONAL INFORMATION ON STORMWATER DROP INLETS AND PIPES.

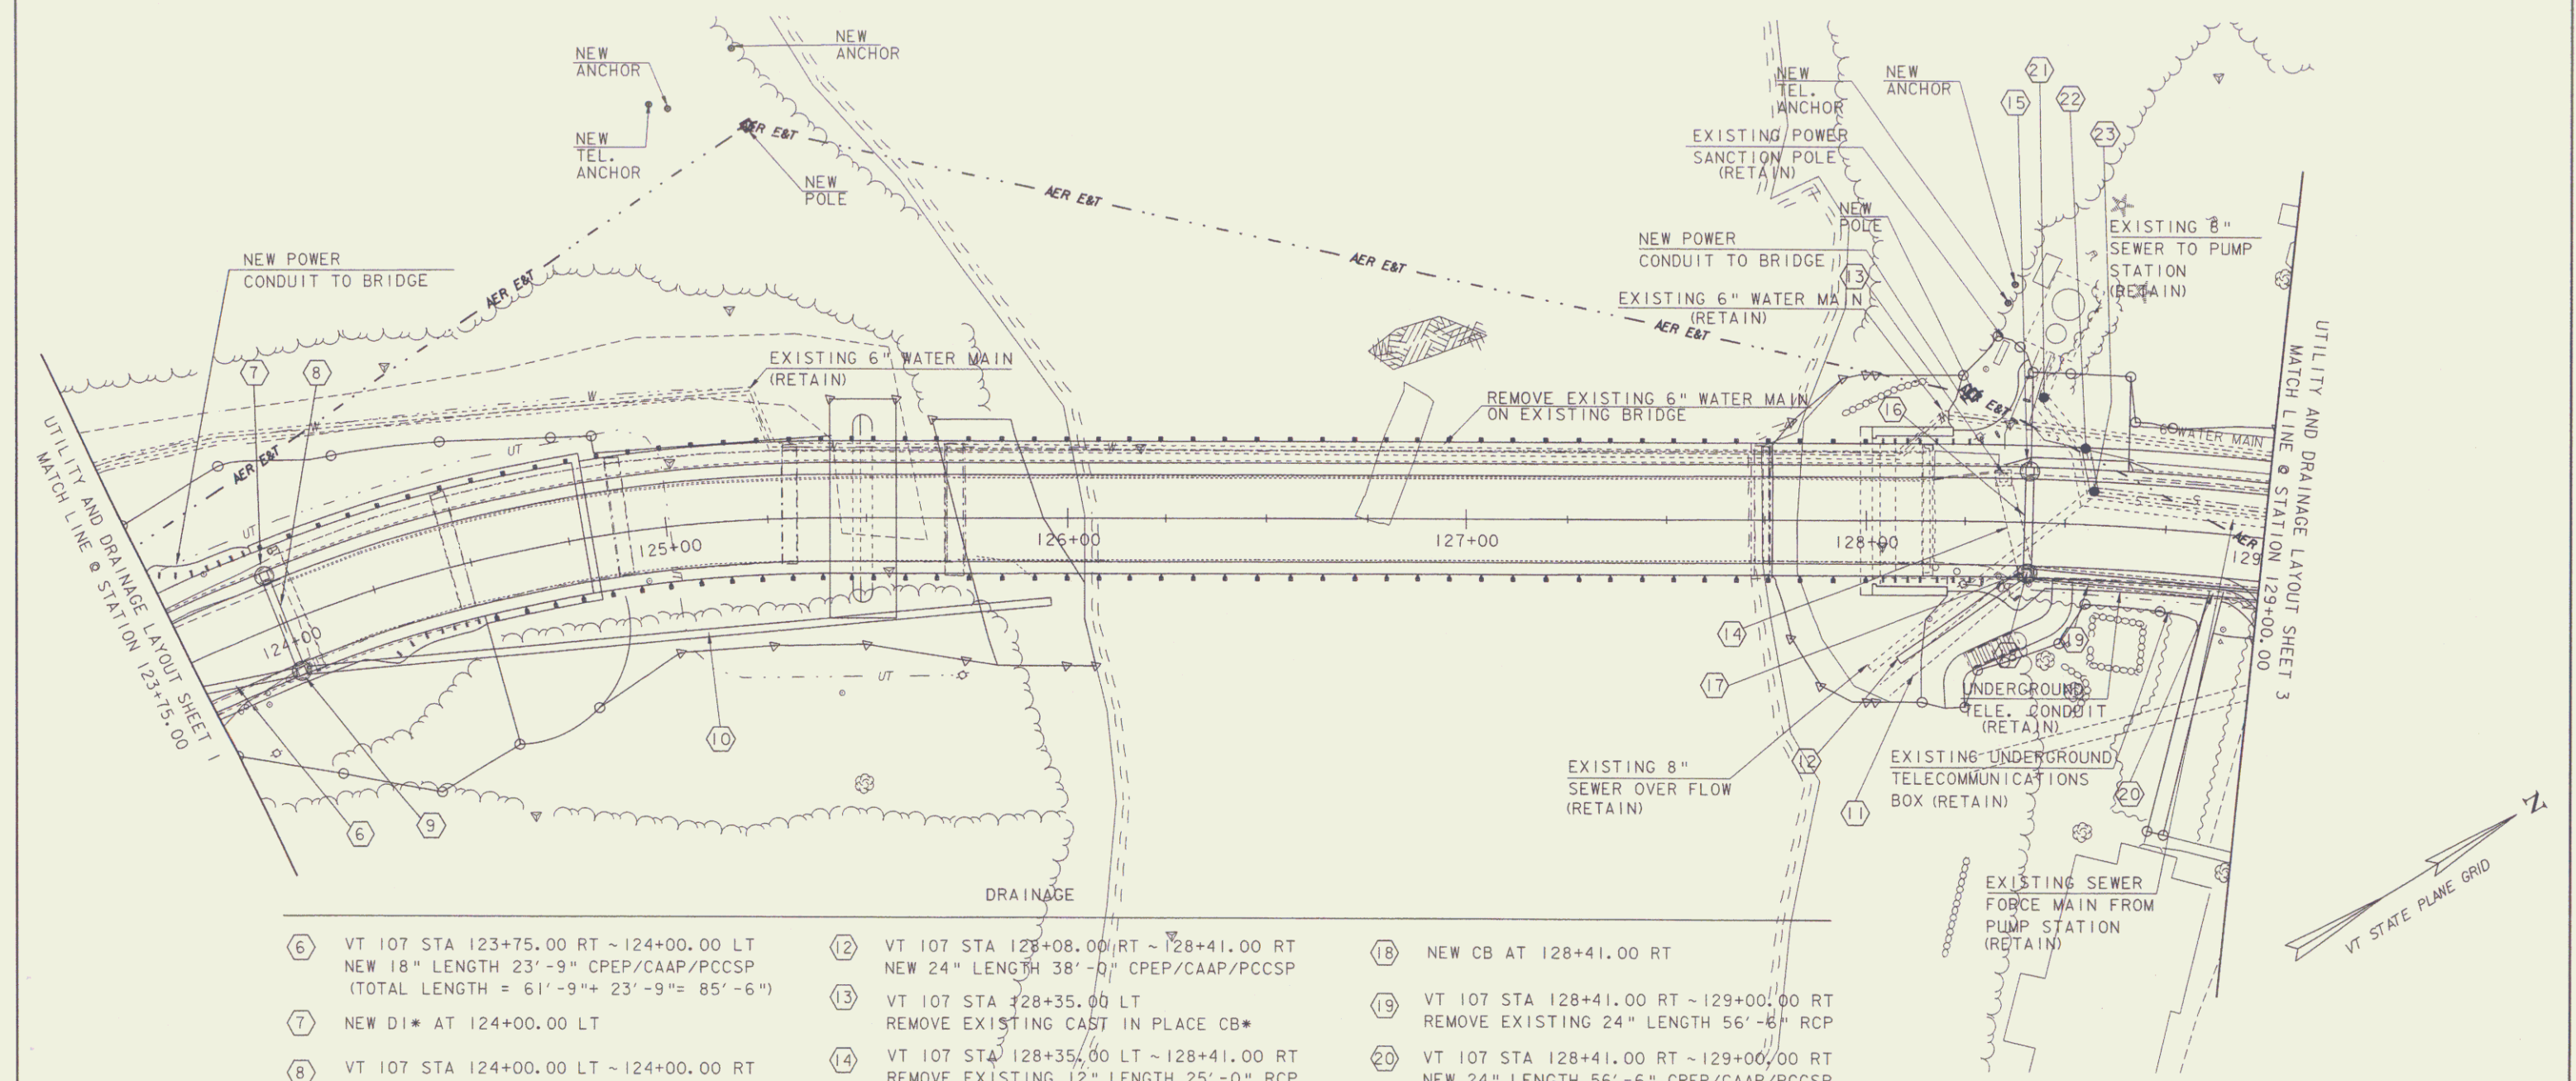

- ⑥ VT 107 STA 123+75.00 RT ~ 124+00.00 LT  
NEW 18" LENGTH 23'-9" CPEP/CAAP/PCCSP  
(TOTAL LENGTH = 61'-9" + 23'-9" = 85'-6")
- ⑦ NEW DI\* AT 124+00.00 LT
- ⑧ VT 107 STA 124+00.00 LT ~ 124+00.00 RT  
NEW 18" LENGTH 23'-0" CPEP/CAAP/PCCSP
- ⑨ NEW CB AT 124+00.00 RT
- ⑩ VT 107 STA 124+00.00 RT ~ 125+95.90 RT  
NEW 18" LENGTH 187'-0" CPEP/CAAP/PCCSP
- ⑪ VT 107 STA 128+00.00 RT ~ 128+41.00 RT  
REMOVE EXISTING 24" LENGTH 40'-0" RCP

- ⑫ VT 107 STA 128+08.00 RT ~ 128+41.00 RT  
NEW 24" LENGTH 38'-0" CPEP/CAAP/PCCSP
- ⑬ VT 107 STA 128+35.00 LT  
REMOVE EXISTING CAST IN PLACE CB\*
- ⑭ VT 107 STA 128+35.00 LT ~ 128+41.00 RT  
REMOVE EXISTING 12" LENGTH 25'-0" RCP
- ⑮ NEW DI\* AT 128+41.00 LT
- ⑯ VT STA 128+41.00 LT ~ 128+41.00 RT  
NEW 18" LENGTH 23'-0" CPEP/CAAP/PCCSP
- ⑰ VT 107 STA 128+41.00 RT  
REMOVE EXISTING CAST IN PLACE CB\*

- ⑱ NEW CB AT 128+41.00 RT
- ⑲ VT 107 STA 128+41.00 RT ~ 129+00.00 RT  
REMOVE EXISTING 24" LENGTH 56'-6" RCP
- ⑳ VT 107 STA 128+41.00 RT ~ 129+00.00 RT  
NEW 24" LENGTH 56'-6" CPEP/CAAP/PCCSP
- ㉑ ADJUST MANHOLE COVER ELEVATION AT  
VT 107 STA 128+43.90
- ㉒ ADJUST MANHOLE COVER ELEVATION AT  
VT 107 STA 128+54.37
- ㉓ ADJUST MANHOLE COVER ELEVATION AT  
VT 107 STA 128+56.87

SCALE 1" = 20'-0"  
20 0 20

**UTILITIES AND DRAINAGE LAYOUT SHEET 2**

PROJECT NAME:	BETHEL	PLOT DATE:	10-FEB-2010
PROJECT NUMBER:	BRF 022-1(14)	DRAWN BY:	G. ROKES
FILE NAME:	ppms*/Section/-----,dgn	CHECKED BY:	S. SCRIBNER
PROJECT LEADER:	M. EVANS-MONGEON	ROW SHEET	11 OF 27 SHEETS
DESIGNED BY:	G. ROKES		