


PLANS FOR NEW ACCESS ROAD (QUARRY ROAD) FOR TWIN STATE SAND & GRAVEL AND FOR GREATER UPPER VALLEY SOLID WASTE MANAGEMENT DISTRICT



LOCATION MAP

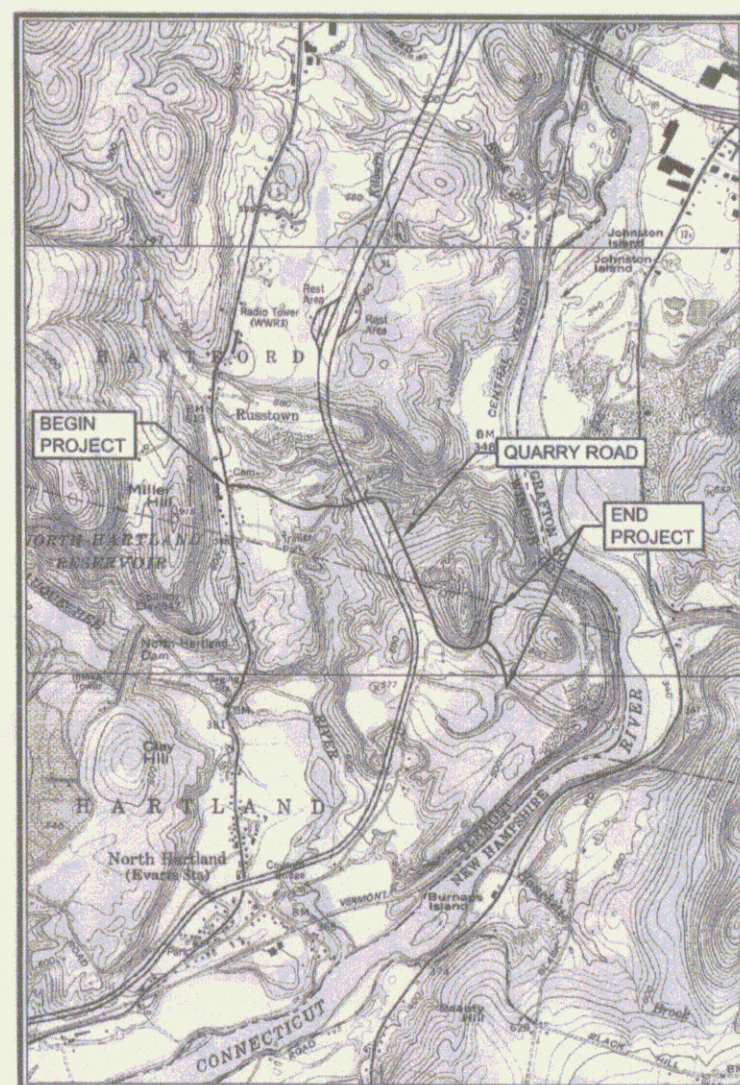

VICINITY MAP
SCALE: 1:24000

m m 67.
+
3602

INDEX OF SHEETS

SHEET	TITLE
	COVER SHEET
C1	TYPICAL SECTIONS
C2	ROUTE 5 PLAN AND PROFILE AT PRIVATE ACCESS ROAD (QUARRY ROAD)
C3	QUARRY ROAD PLAN AND PROFILE
C4	QUARRY ROAD PLAN AND PROFILE
C5	QUARRY ROAD PLAN AND PROFILE
C6	QUARRY ROAD PLAN AND PROFILE
C6A	QUARRY ROAD & G.U.V. LANDFILL ACCESS ROAD PLAN AND PROFILE
C6B	QUARRY ROAD & G.U.V. LANDFILL ACCESS ROAD PLAN AND PROFILE
C7	BRIDGE PLAN AND ELEVATION OVER INTERSTATE 91
C8	TYPICAL BRIDGE SECTION & MISCELLANEOUS DETAILS
C9	I-91 TRAFFIC MANAGEMENT PLAN
C10	I-91 EXISTING CENTERLINE PROFILE AND TRAFFIC CONTROL DETAIL
C11	ROUTE 5 CROSS SECTIONS
C12	QUARRY ROAD CROSS SECTIONS STA. 0+00 TO STA. 17+00
C13	QUARRY ROAD CROSS SECTIONS STA. 18+00 TO STA. 20+00
C14	QUARRY ROAD CROSS SECTIONS STA. 21+00 TO STA. 29+00
C15	QUARRY ROAD CROSS SECTIONS STA. 30+00 TO STA. 37+00
C16	QUARRY ROAD CROSS SECTIONS STA. 38+00 TO STA. 45+00
C17	QUARRY ROAD CROSS SECTIONS STA. 46+00 TO STA. 55+00
C18	QUARRY ROAD CROSS SECTIONS STA. 56+00 TO STA. 65+00
C18A	QUARRY ROAD CROSS SECTIONS STA. 66+00 TO STA. 73+00
C18B	QUARRY ROAD CROSS SECTIONS STA. 74+00 TO 76+74 AND LANDFILL ACCESS ROAD STA. 900+00 TO STA. 904+00
C18C	LANDFILL ACCESS ROAD STA. 905+00 TO STA. 909+65
C19	PROPOSED BLAKE ROAD ENTRANCE CENTERLINE PROFILE AND CROSS SECTIONS
C20	PROPOSED GRAVEL MOBILE HOME ACCESS ROAD CENTERLINE PROFILE AND CROSS SECTIONS
C21	EROSION CONTROL DETAILS AND MISCELLANEOUS CONSTRUCTION DETAILS

PROPOSED LINED LANDFILL PROJECT LOCATION - HARTFORD & HARTLAND, VT.

TOWNS OF
HARTFORD - HARTLAND
Project: HARTFORD & HARTLAND
GUVSWMD
Pin # 13R234
Route: I91
Date 8/1/2001

JANUARY • 2000
REVISED AUGUST • 2001
PRELIMINARY - FOR REVIEW ONLY


Mile Points
Hartford 67.817-67.502
Hartland 67.502-67.436




North Springfield, Vermont
Tel. (802) 886-2261 • FAX (802) 886-2260 • www.d-hinc.com

Consulting Engineers


OFFICES:
No. Springfield, Vermont
Southfield, Vermont
Southfield, New Hampshire
Portland, Maine
Westfield, Massachusetts
Greenfield, Massachusetts
Billerica, Massachusetts
Fort Collins, Colorado
Sarasota, Florida
Hialeah, Florida
Birmingham, Alabama

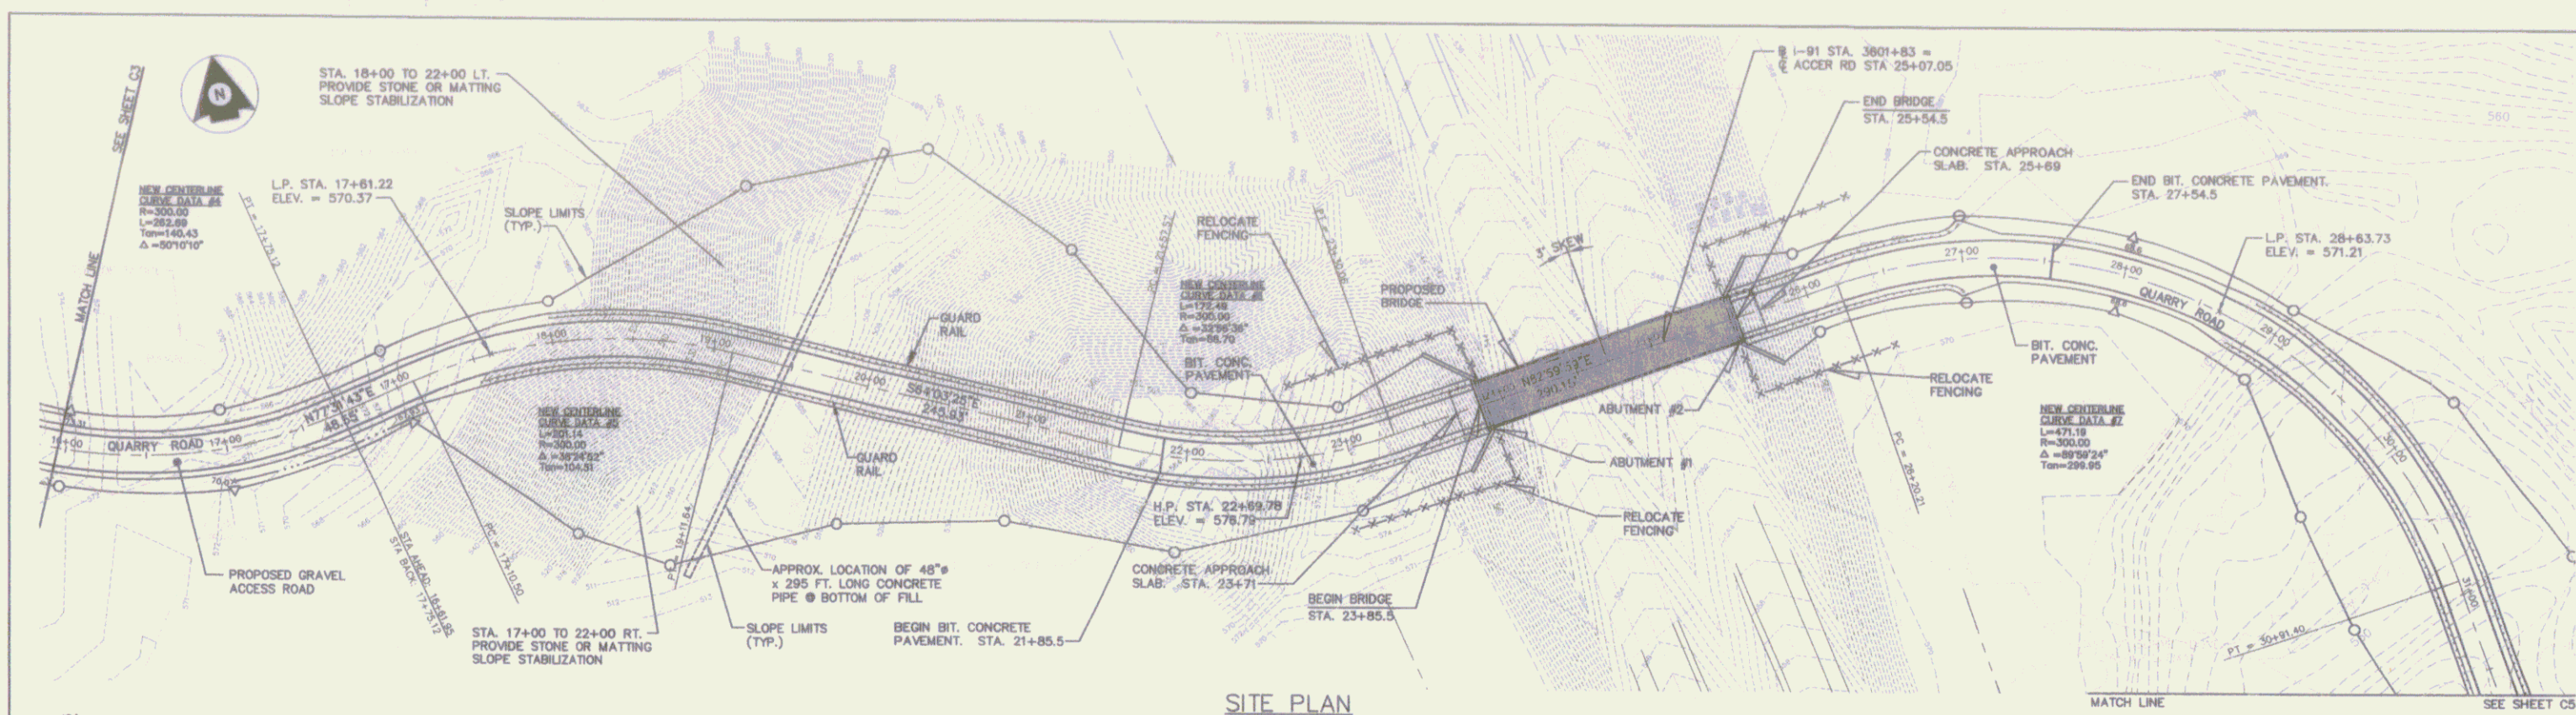

SITE PLAN
 SCALE: 1" = 50'

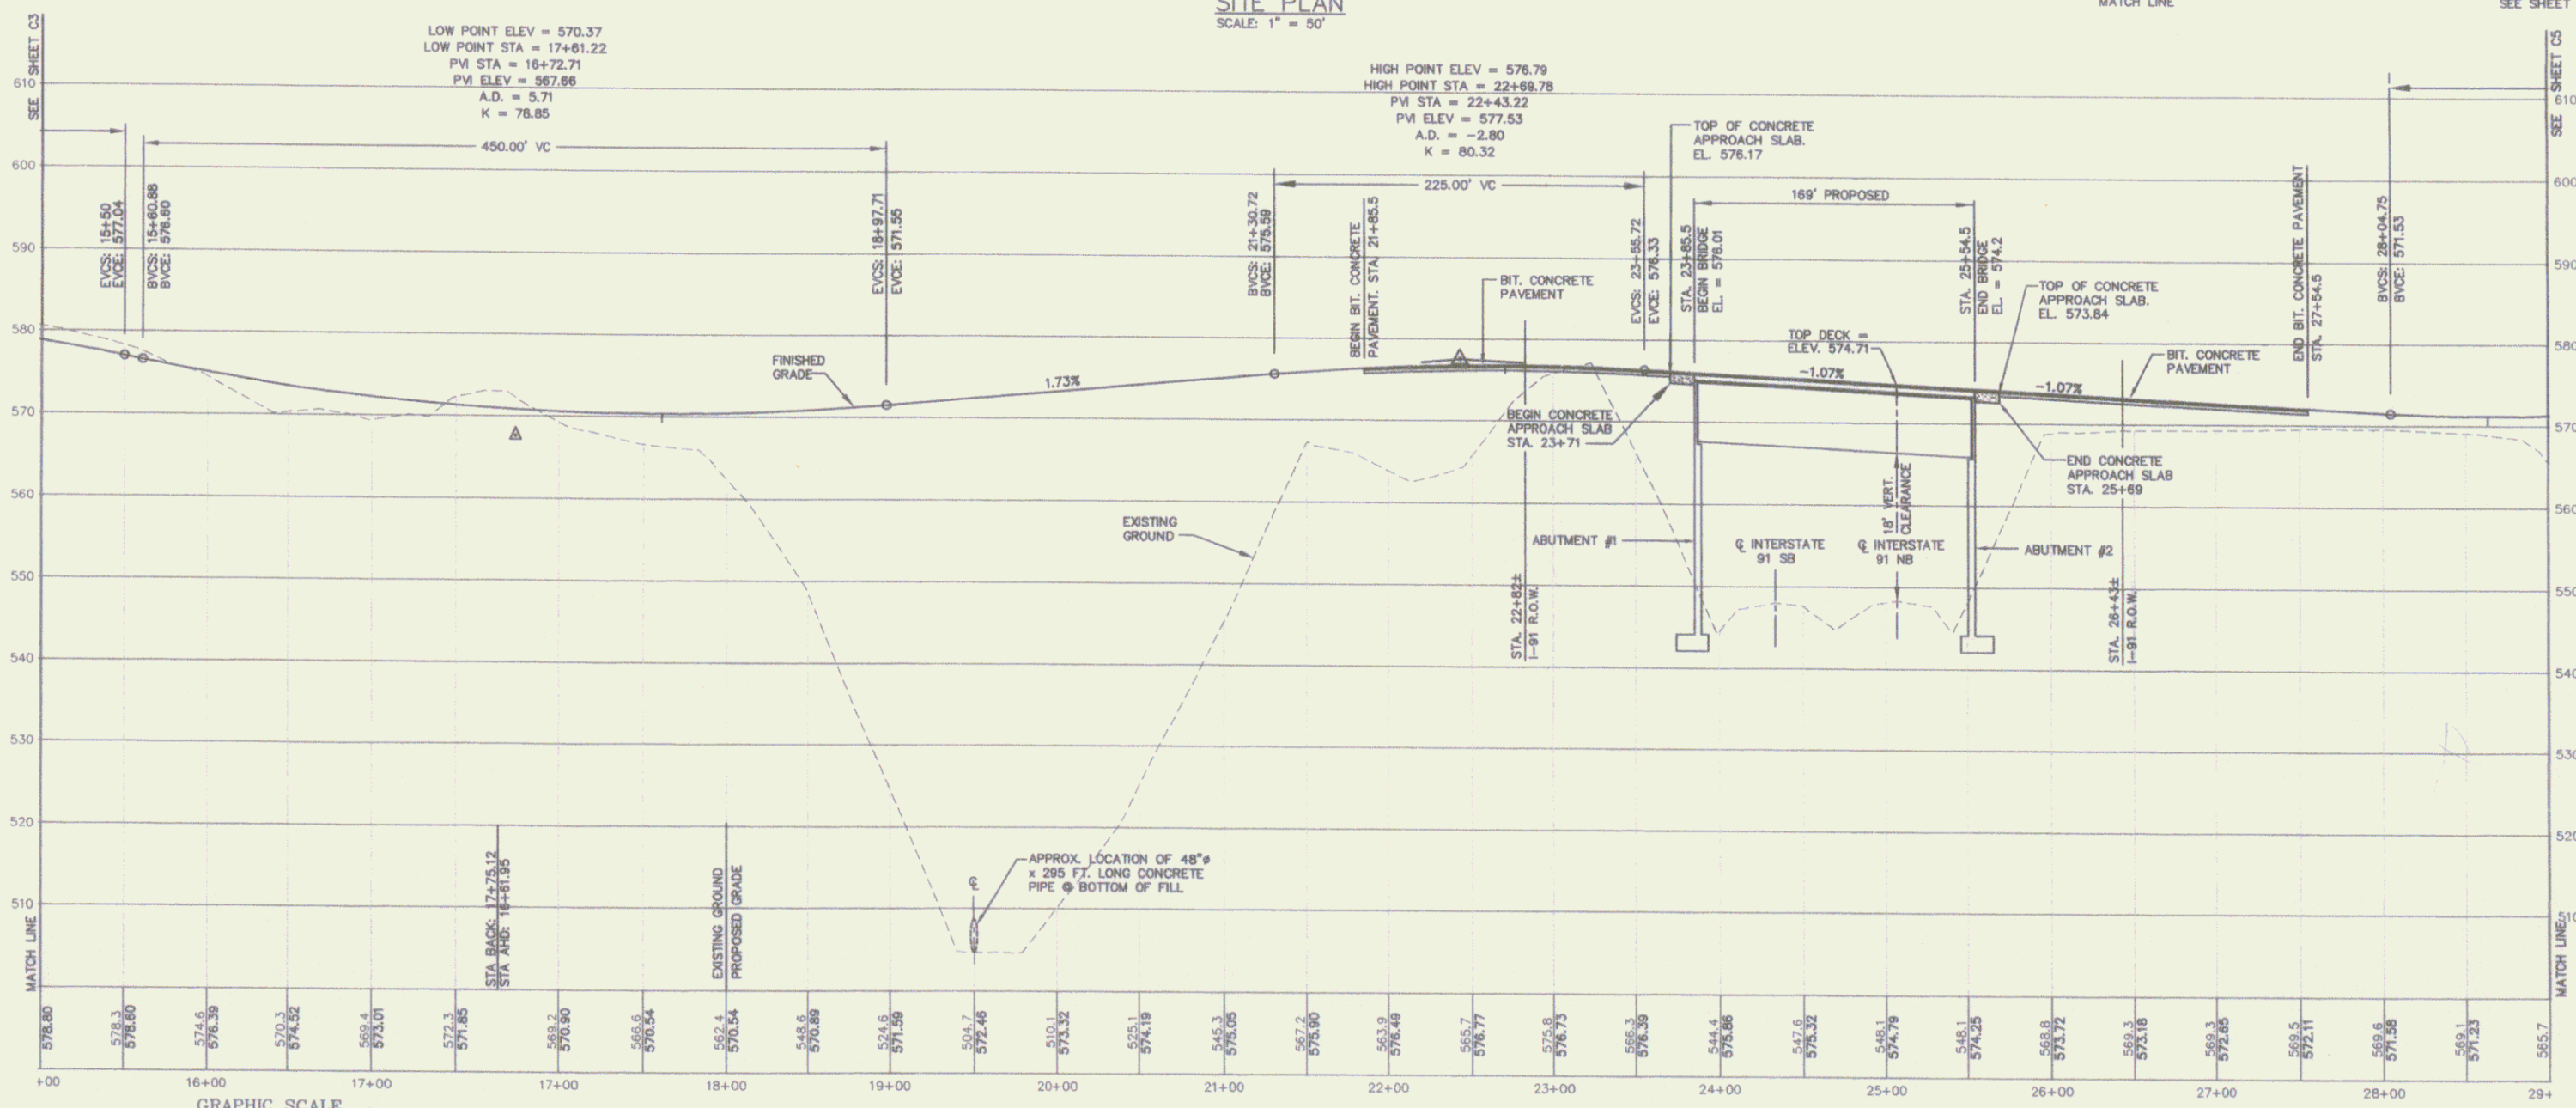

NEW CENTERLINE PROFILE
 SCALE: 1" = 50' HORIZ.
 1" = 10' VERT.

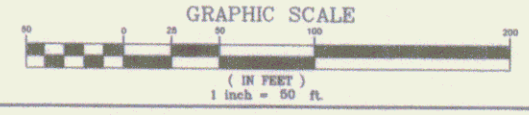



Project No.	300078
Prop. Manager	R.L. BACON
Proj. Designer	BACON/DODDLE
Drawn By	DODDLE/MEDCOM
Checked By	R.L. BACON
Scale	AS SHOWN
Approved	
Date	JANUARY 2000

GREATER UPPER VALLEY SOLID WASTE MANAGEMENT DISTRICT
 PROPOSED ACCESS ROAD
QUARRY ROAD PLAN AND PROFILE


Project No.	300078
Prop. Manager	R.L. BACON
Proj. Designer	BACON/DODDLE
Drawn By	DODDLE/MEDCOM
Checked By	R.L. BACON
Scale	AS SHOWN
Approved	
Date	JANUARY 2000

C4

Sheet 4 of 4
 D

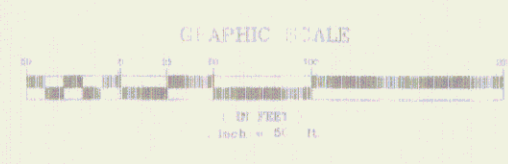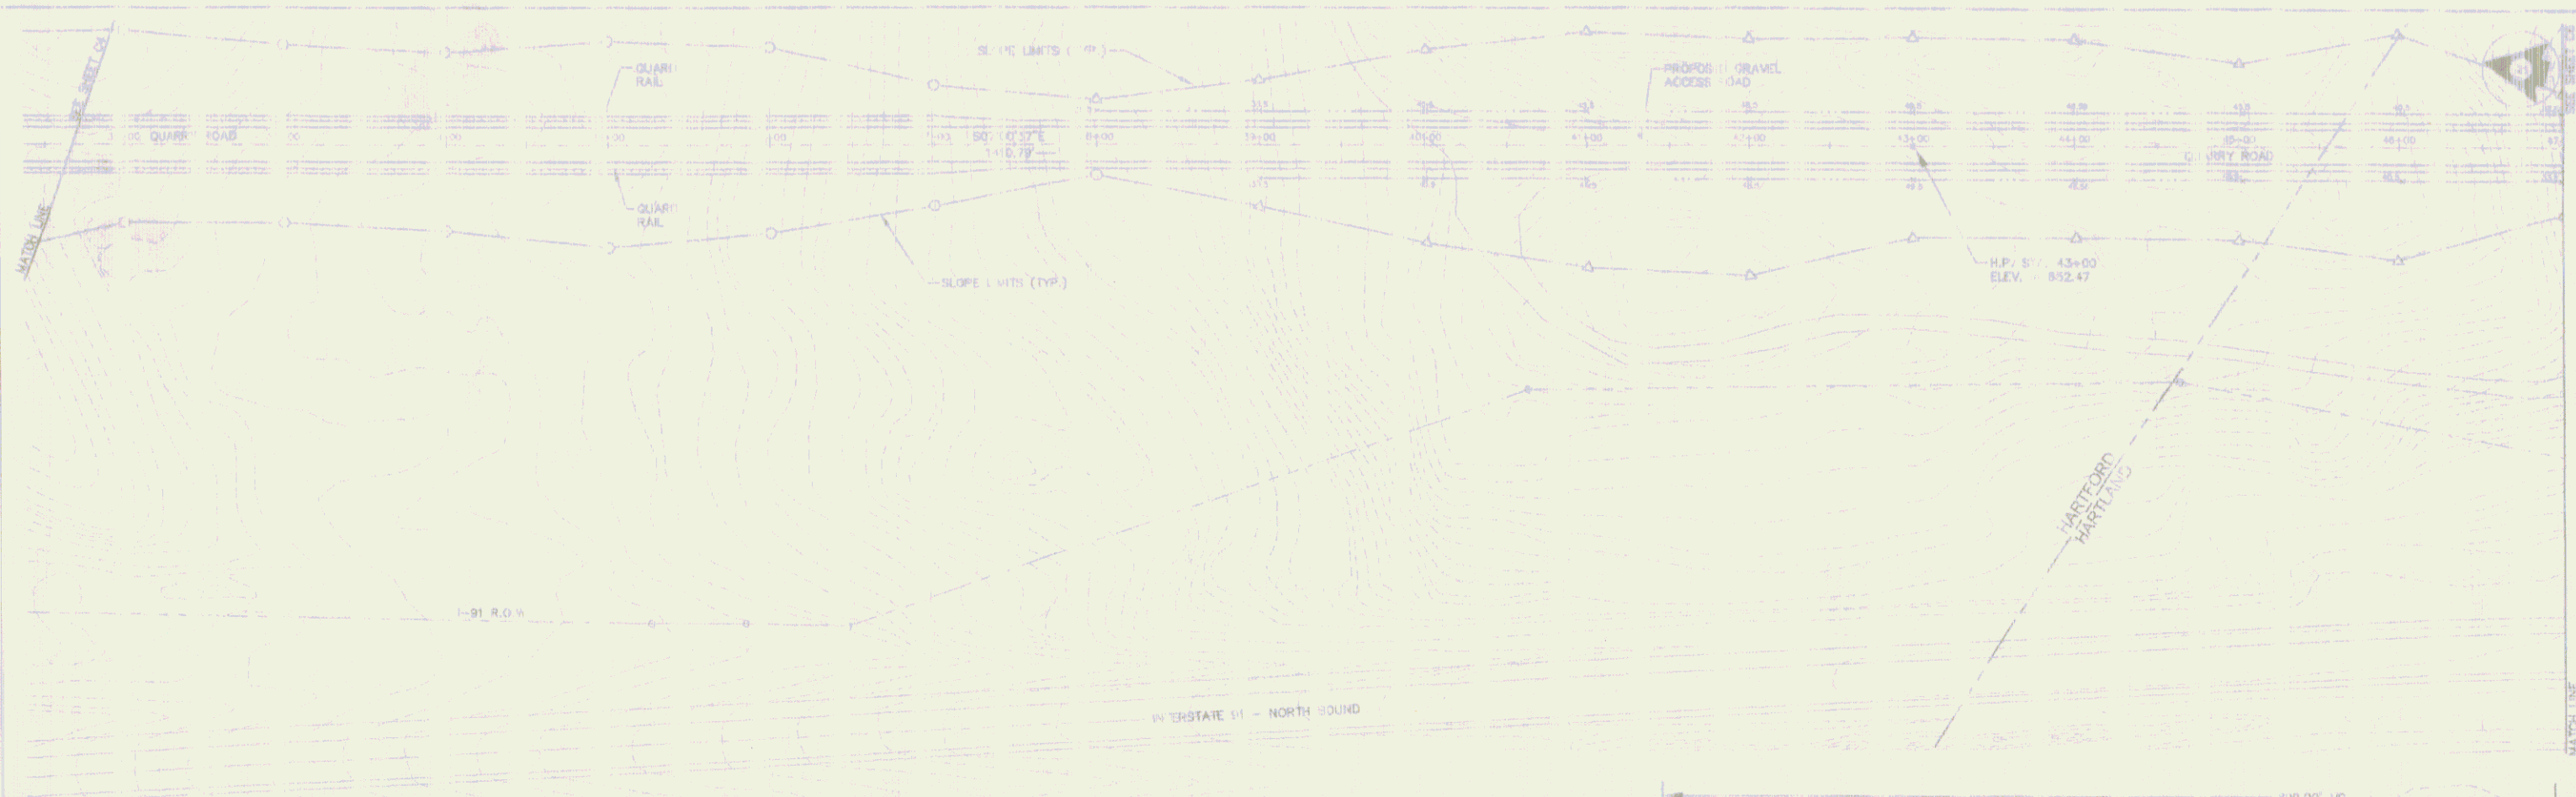

SITE PLAN
SCALE: 1" = 50'

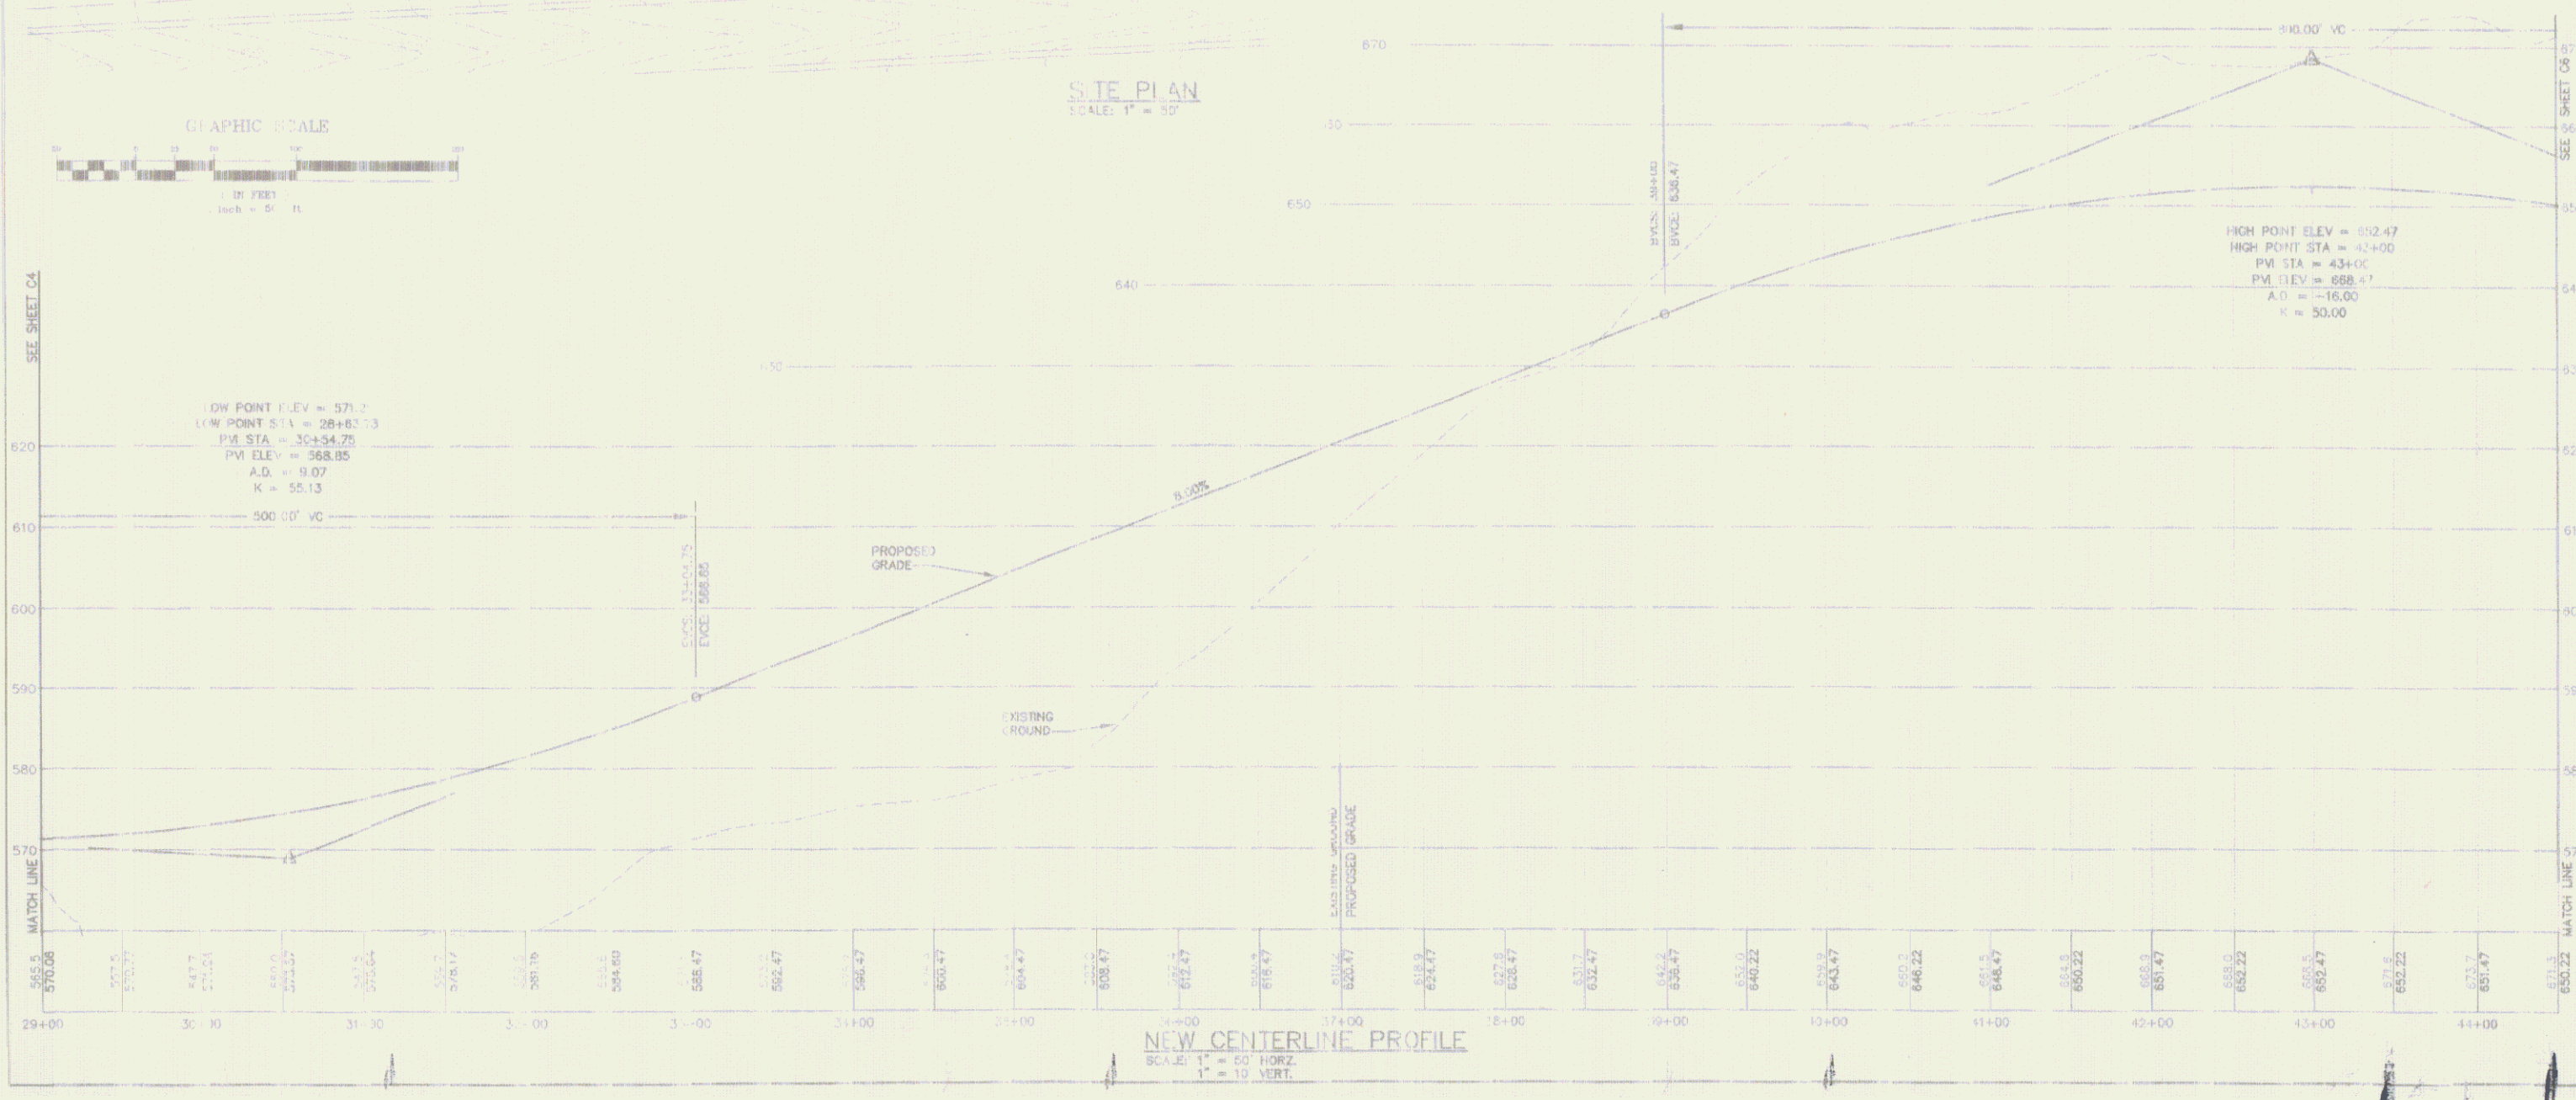


PROJECT	GREATER UPPER VALLEY SOLID WASTE MANAGEMENT DISTRICT PROPOSED ACCESS ROAD
DATE	1/11/11
SCALE	AS SHOWN
DESIGNER	R.L. BACON
CHECKED BY	R.L. BACON
APPROVED	AS SHOWN
DATE	JAN 11/11

GREATER UPPER VALLEY SOLID WASTE MANAGEMENT DISTRICT
PROPOSED ACCESS ROAD
QUARRY ROAD PLAN AND PROFILE

PROJECT NO.	2007010
PROJECT NAME	GREATER UPPER VALLEY SOLID WASTE MANAGEMENT DISTRICT PROPOSED ACCESS ROAD
DATE	1/11/11
SCALE	AS SHOWN
DESIGNER	R.L. BACON
CHECKED BY	R.L. BACON
APPROVED	AS SHOWN
DATE	JAN 11/11


C5

Sheet 3 of 3

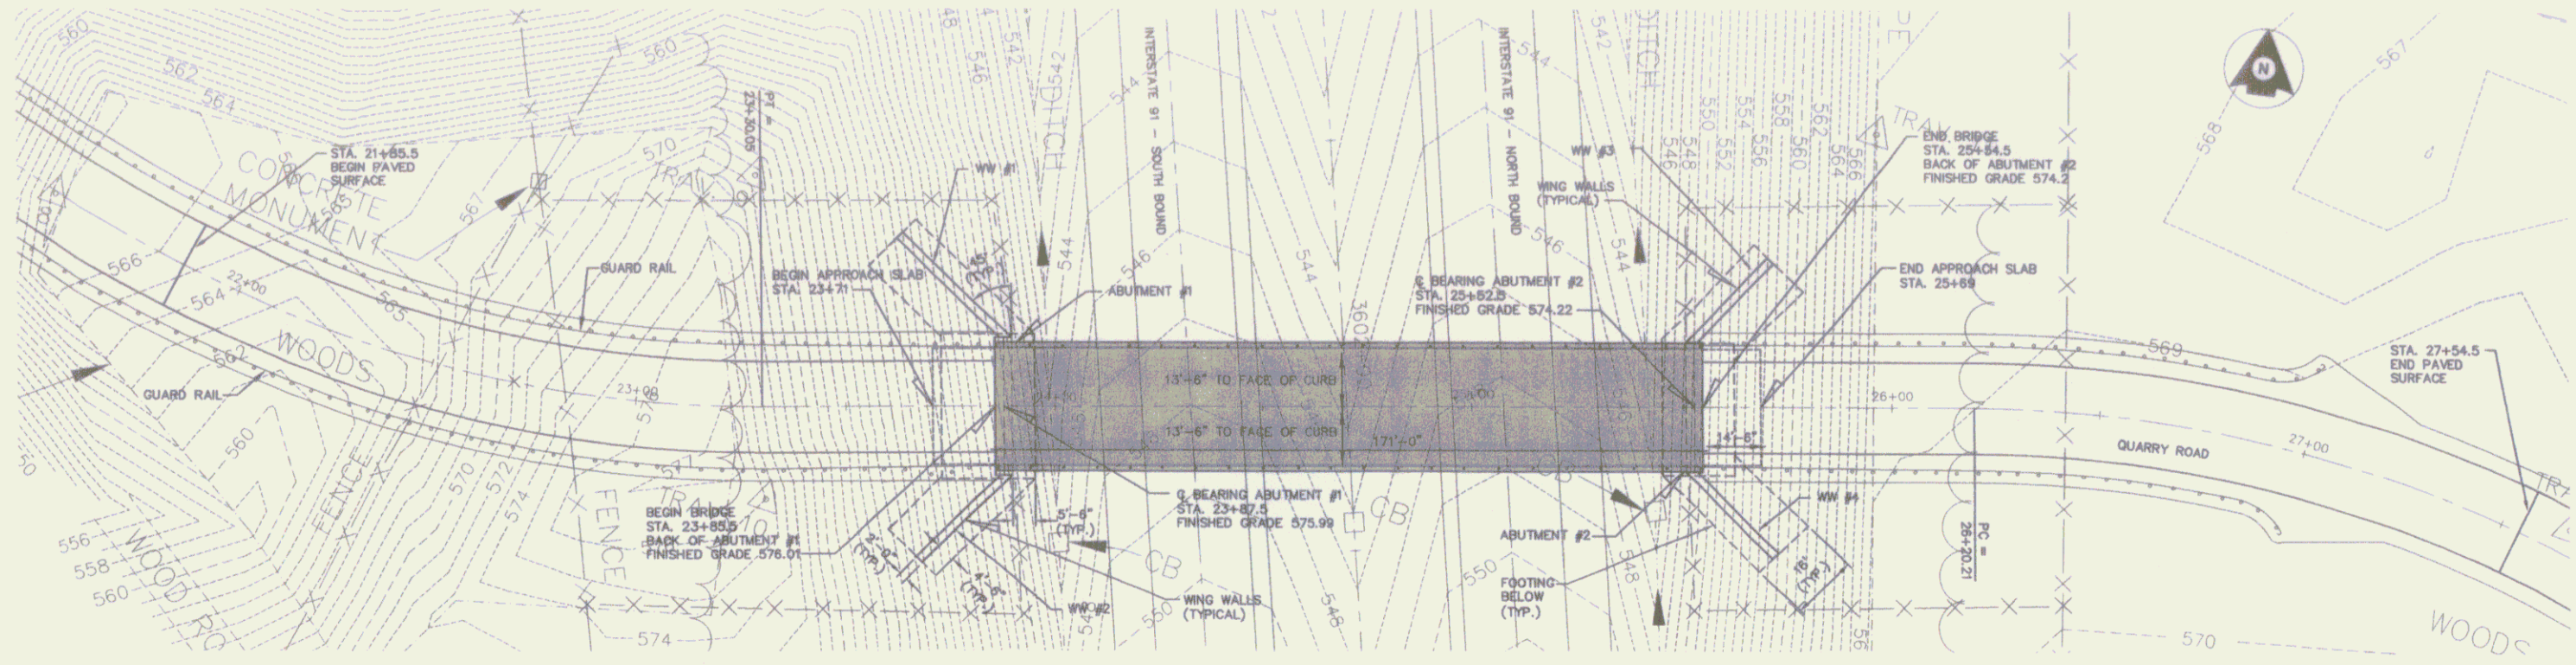


NOTE: WING WALL INFORMATION
 WW #1 HP 575.0 EL. LP 564.0 EL.
 WW #2 HP 575.0 EL. LP 566.0 EL.
 WW #3 HP 573.0 EL. LP 564.0 EL.
 WW #4 HP 573.0 EL. LP 564.0 EL.

PLAN
 SCALE: 1" = 20'

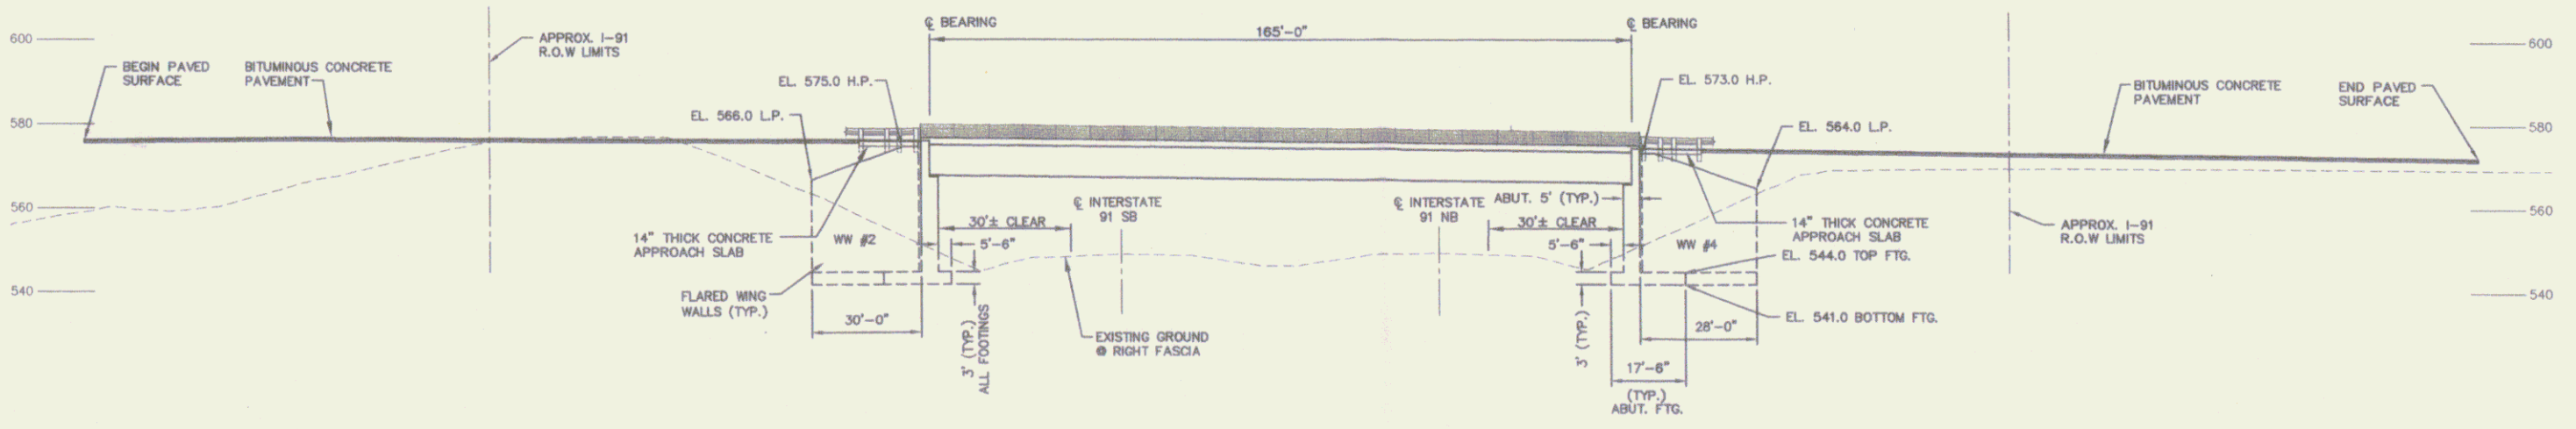

NOTES.
 1. NETC BRIDGE RAIL WITH SNOW FENCE PER BR 3-97.

ELEVATION
 SCALE: 1" = 20' HORIZ.
 1" = 20' VERT.

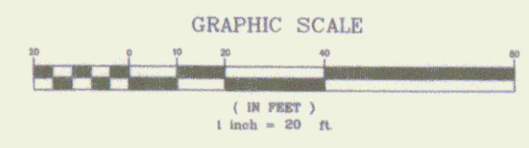

Project No.	2002015
Prop. Manager	R.L. BROWN
Prop. Designer	G.A. BOULE
Drawn By	B.V. DEBROSIA/J.P.
Checked By	
Scale	1" = 20'
Approved	
Date	JANUARY 2002

GREATER UPPER VALLEY SOLID WASTE MANAGEMENT DISTRICT
 PROPOSED ACCESS ROAD
**BRIDGE PLAN AND ELEVATION
 OVER INTERSTATE 91**

Project No.	2002015
Prop. Manager	R.L. BROWN
Prop. Designer	G.A. BOULE
Drawn By	B.V. DEBROSIA/J.P.
Checked By	
Scale	1" = 20'
Approved	
Date	JANUARY 2002

C7

Sheet **7** of **7**