

INDEX TO SHEETS


SHEET NO.	TITLE PAGE AND TYPICAL SECTIONS
2	PLAN AND PROFILE STA. 0+00 TO STA. 16+00
3	16+00 - 31+00
4	31+00 - 45+00
5	45+00 - 60+00
6	60+00 - 74+00
7	74+00 - 89+00
8	89+00 - 103+00
9	103+00 - 118+00
10	118+00 - 132+00
11-24	CROSS SECTIONS
25	BRIDGE
26	111+02.5

TOWN OF BENNINGTON

**PLAN AND PROFILE OF PROPOSED IMPROVEMENT
STATE HIGHWAY NO. 2
FROM PERCEY'S CORNER TO NORTH BENNINGTON VILLAGE**

Route: **VT 67A**
Project: **MsB15**
Plan: **002408**
Date: **02/08/1921**

Scales: Plan - 1" = 500'
Profile - Hor. 1" = 500', Vert. 1" = 10'
Cross Sections 10" = 50'

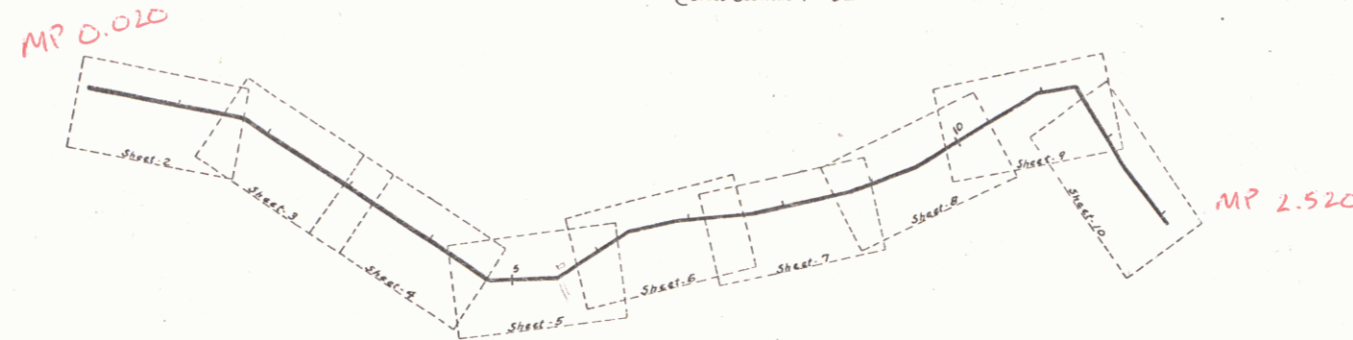

SUMMARY OF QUANTITIES



EARTH EXCAVATION	4077	CU YDS.
BORROW	735	"
CEMENT CONCRETE PAVEMENT REINFORCED	4565	"
1-2-4 CONCRETE (CLASS A)	30	"
1-3-6 CONCRETE (CLASS C)	37	"
X WOODEN GUARD RAIL	1132	LIN. FT.
VERIFIED LEACHING BASINS		
X CRUSHED STONE OR GRAVEL FOR SHOULDERS	2130	CU YDS.
ROCK EXCAVATION	20	"
CONCRETE AT R.R. CROSSINGS	67	"
REINFORCING STEEL	450	LBS.
X BROKEN STONE OR GRAVEL FOR DRAINS	175	CU YDS.
STANDARD UNDERDRAIN	1010	LIN. FT.
SUB BASE	2346	CU YDS.
RECONSTRUCTED SUB BASE	268	"
SAND OR GRAVEL CUSHION	1800	"
X 1-2-4 CONCRETE (CLASS A) FOR STRUCTURES OVER 4 FT SPAN EXCL. YDS.	146	"
X 1-3-6 CONCRETE (CLASS C)		
X REINFORCING STEEL		9011 LBS.

X = OPTIONAL ITEMS

LAYOUT

Scale - 1" = 1000'



TYPICAL SECTIONS

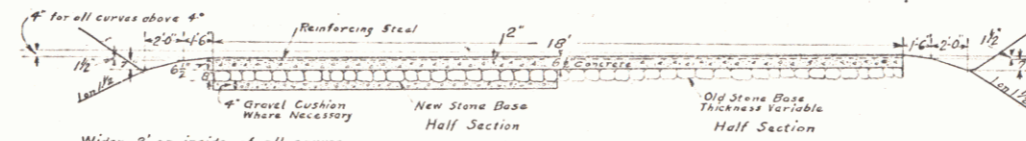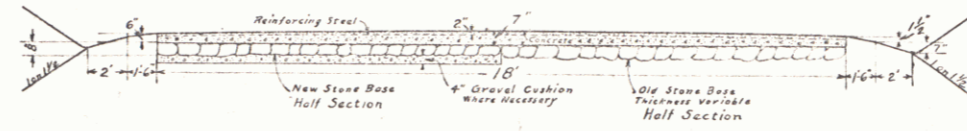

Widen 2' on inside of all curves greater than 5° curvatures. Widen on outside of curves as directed.

SECTION ON R.R. CROSSING

Scale: Hor. 1" = 25', Vert. 1" = 5'

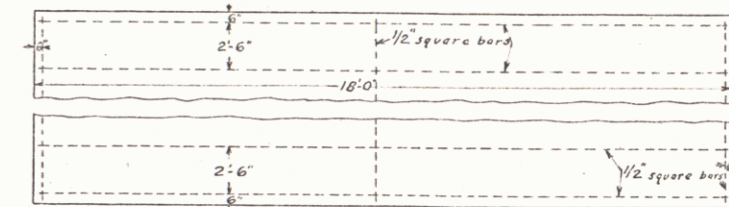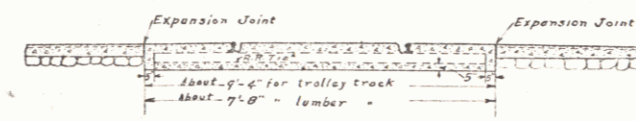

PLAN SHOWING BAR REINFORCING
Scale: Hor. 1" = 25', Vert. 1" = 5'

Project: **Bennington**

Location: **0.25 mile south from Percy's corner near road to Bennington Village**

Year: **1921**

Contractor: **Concrete**

SIGNS

GROUND ELEVATION	Station
GRADE ELEVATION	Station
BASE OF RAIL (on profile)	
CURVE DATA	
DEFLECTION ANGLE	Δ
DEGREE OF CURVE	D
RADIUS OF CURVE	R
TANGENT DISTANCE	T
LENGTH OF CURVE	L
EXTERNAL DISTANCE	E
POINT OF INTERSECTION	P.I.
POINT OF CURVE	P.C.
POINT OF TANGENT	P.T.

H. M. McIntosh
STATE ENGINEER

2/8/21

RIGHT-OF-WAY DIVISION
TOWN FILE
PERPETUAL
Town of **VT 67A**
(To Be Returned To R.O.W. Division)