


**BRIDGE 87S GIRDER ELEVATION**

SCALE: HORIZ.  $\frac{3}{8}$ " = 1'-0"  
 VERT.  $\frac{3}{4}$ " = 1'-0"

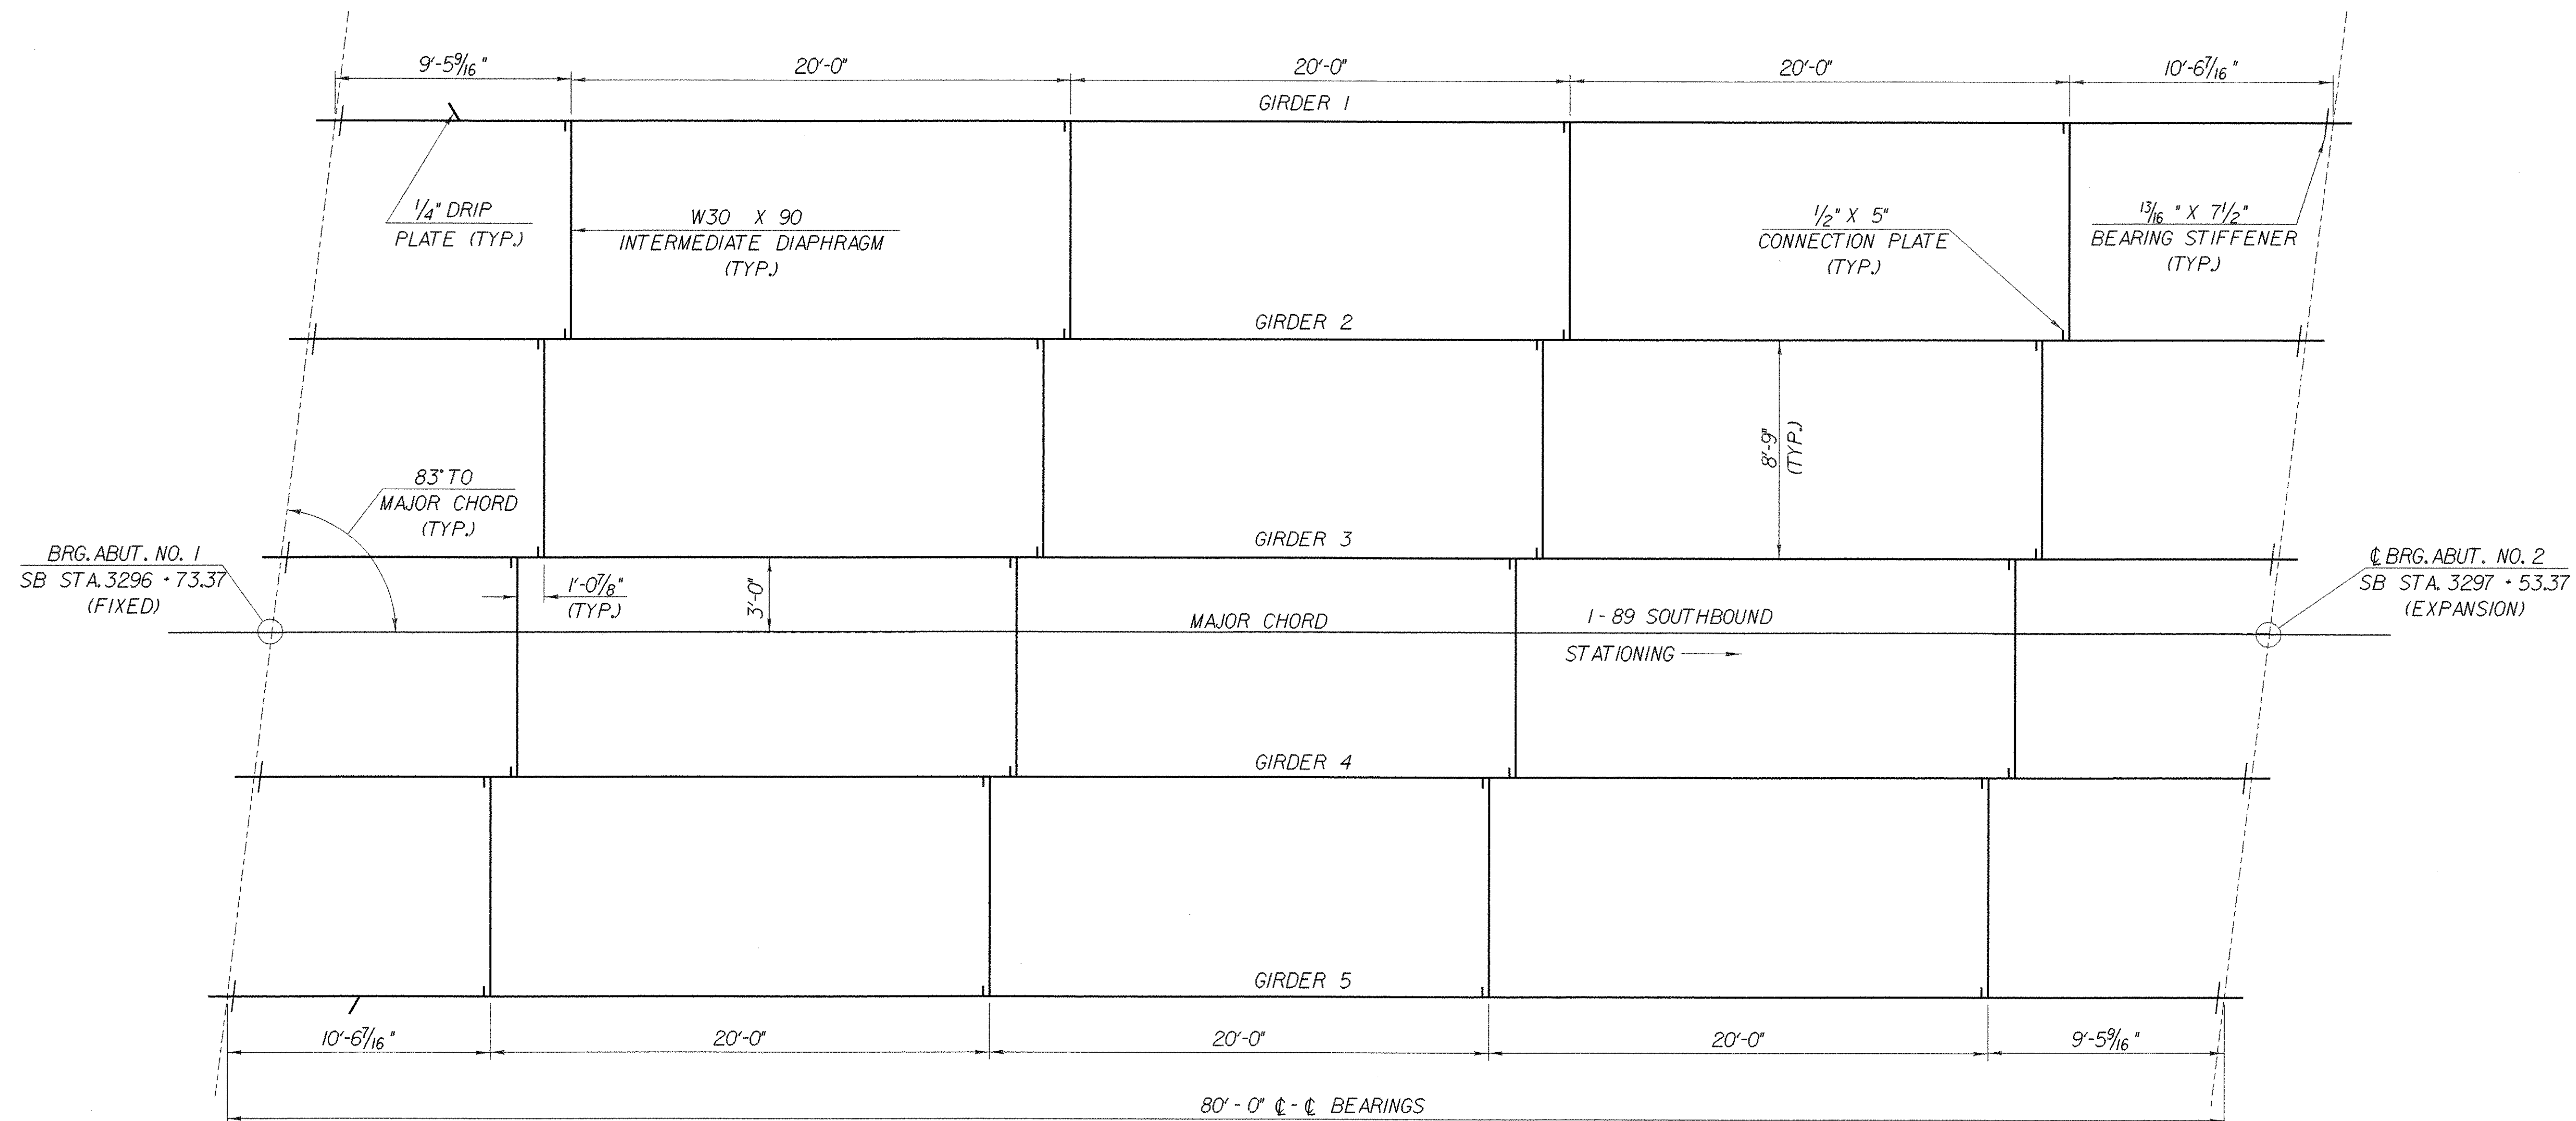

**BRIDGE 87S FRAMING PLAN**

SCALE: 1/4" = 1'-0"

<b>STATE OF VERMONT AGENCY OF TRANSPORTATION</b>			
Town Of <b>FAIRFAX-FAIRFIELD-ST. ALBANS</b>	Bridge No. <b>87 S</b>		
Highway No. <b>1-89</b>	Log Sta. <b>1-89</b>		
<b>1-89 SB OVER VT 104</b>			
<b>87S FRAMING PLAN DETAILS</b>			
Designed By <b>M. LOZIER</b>	Date <b>10/99</b>	Drawn By <b>K. CHISHOLM</b>	Bridge Design Supervisor <b>R. R. WHITCOMB</b> Date <b>11/99</b>
PROJECT <b>FAIRFAX-FAIRFIELD-ST. ALBANS I M 089 - 3 (27)</b>		PROJECT NO. <b>sa0561r41</b>	
I.G.C. Info. <b>941106Structures\1106fr.dgn</b>		sa0561r41	
Bridge Sheet No. <b>BR206</b>	Sheet <b>84</b> of <b>370</b>		