



PLAN
SCALE: 1/8" = 1'-0"

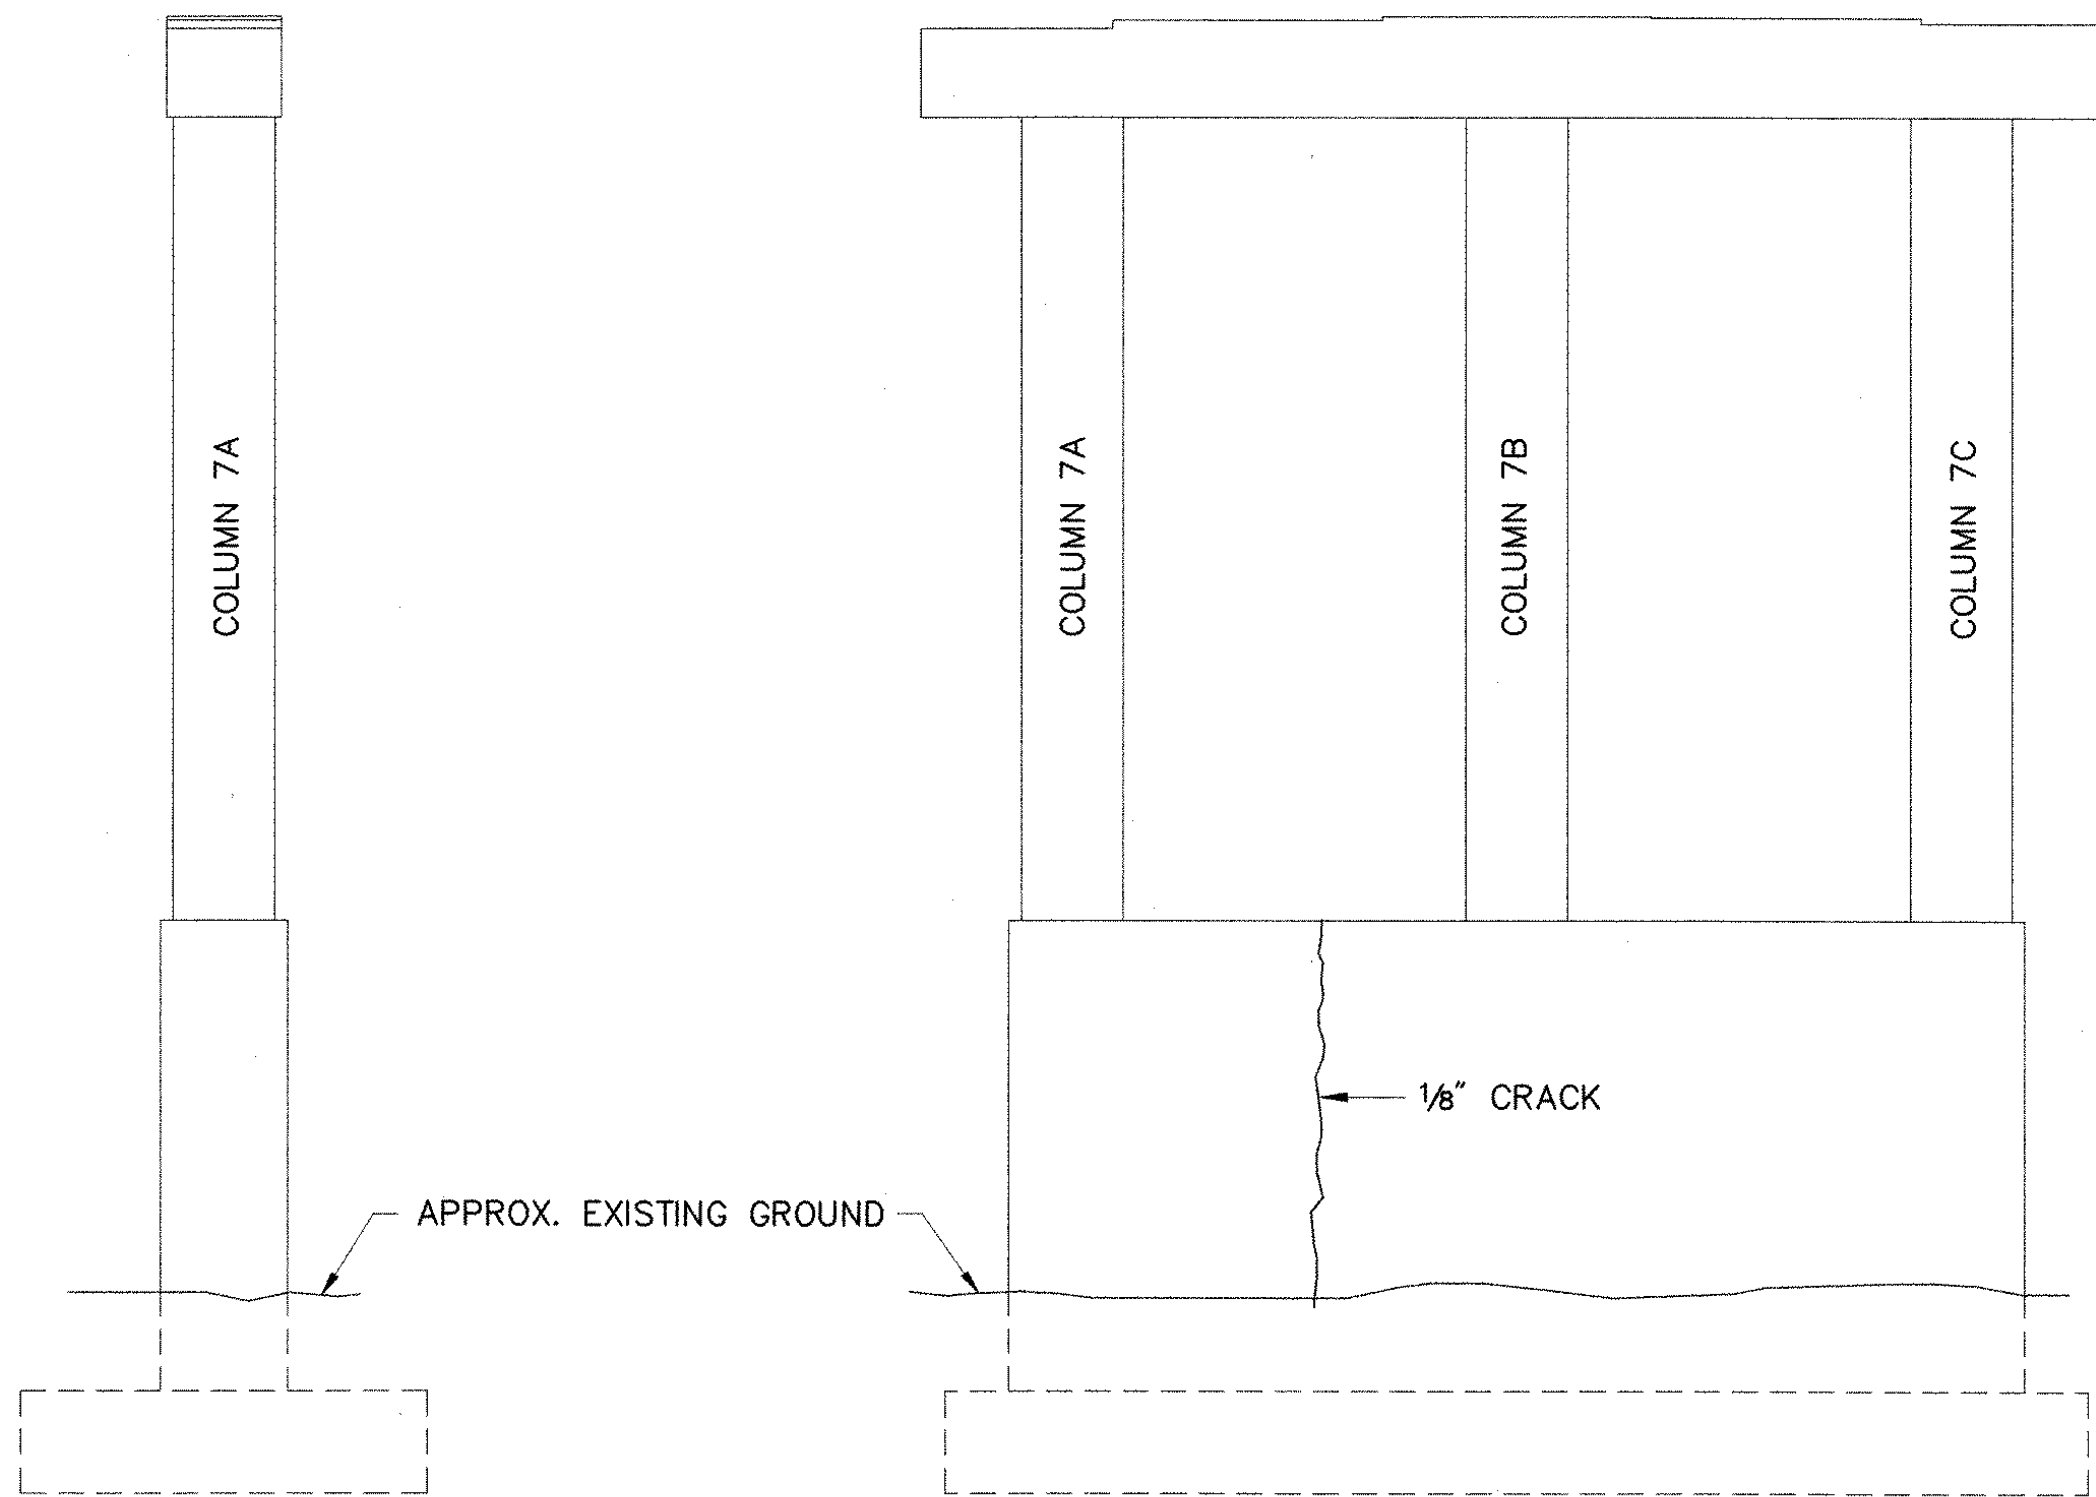

EAST END VIEW
SCALE: 1/8" = 1'-0"

NORTH ELEVATION
SCALE: 1/8" = 1'-0"

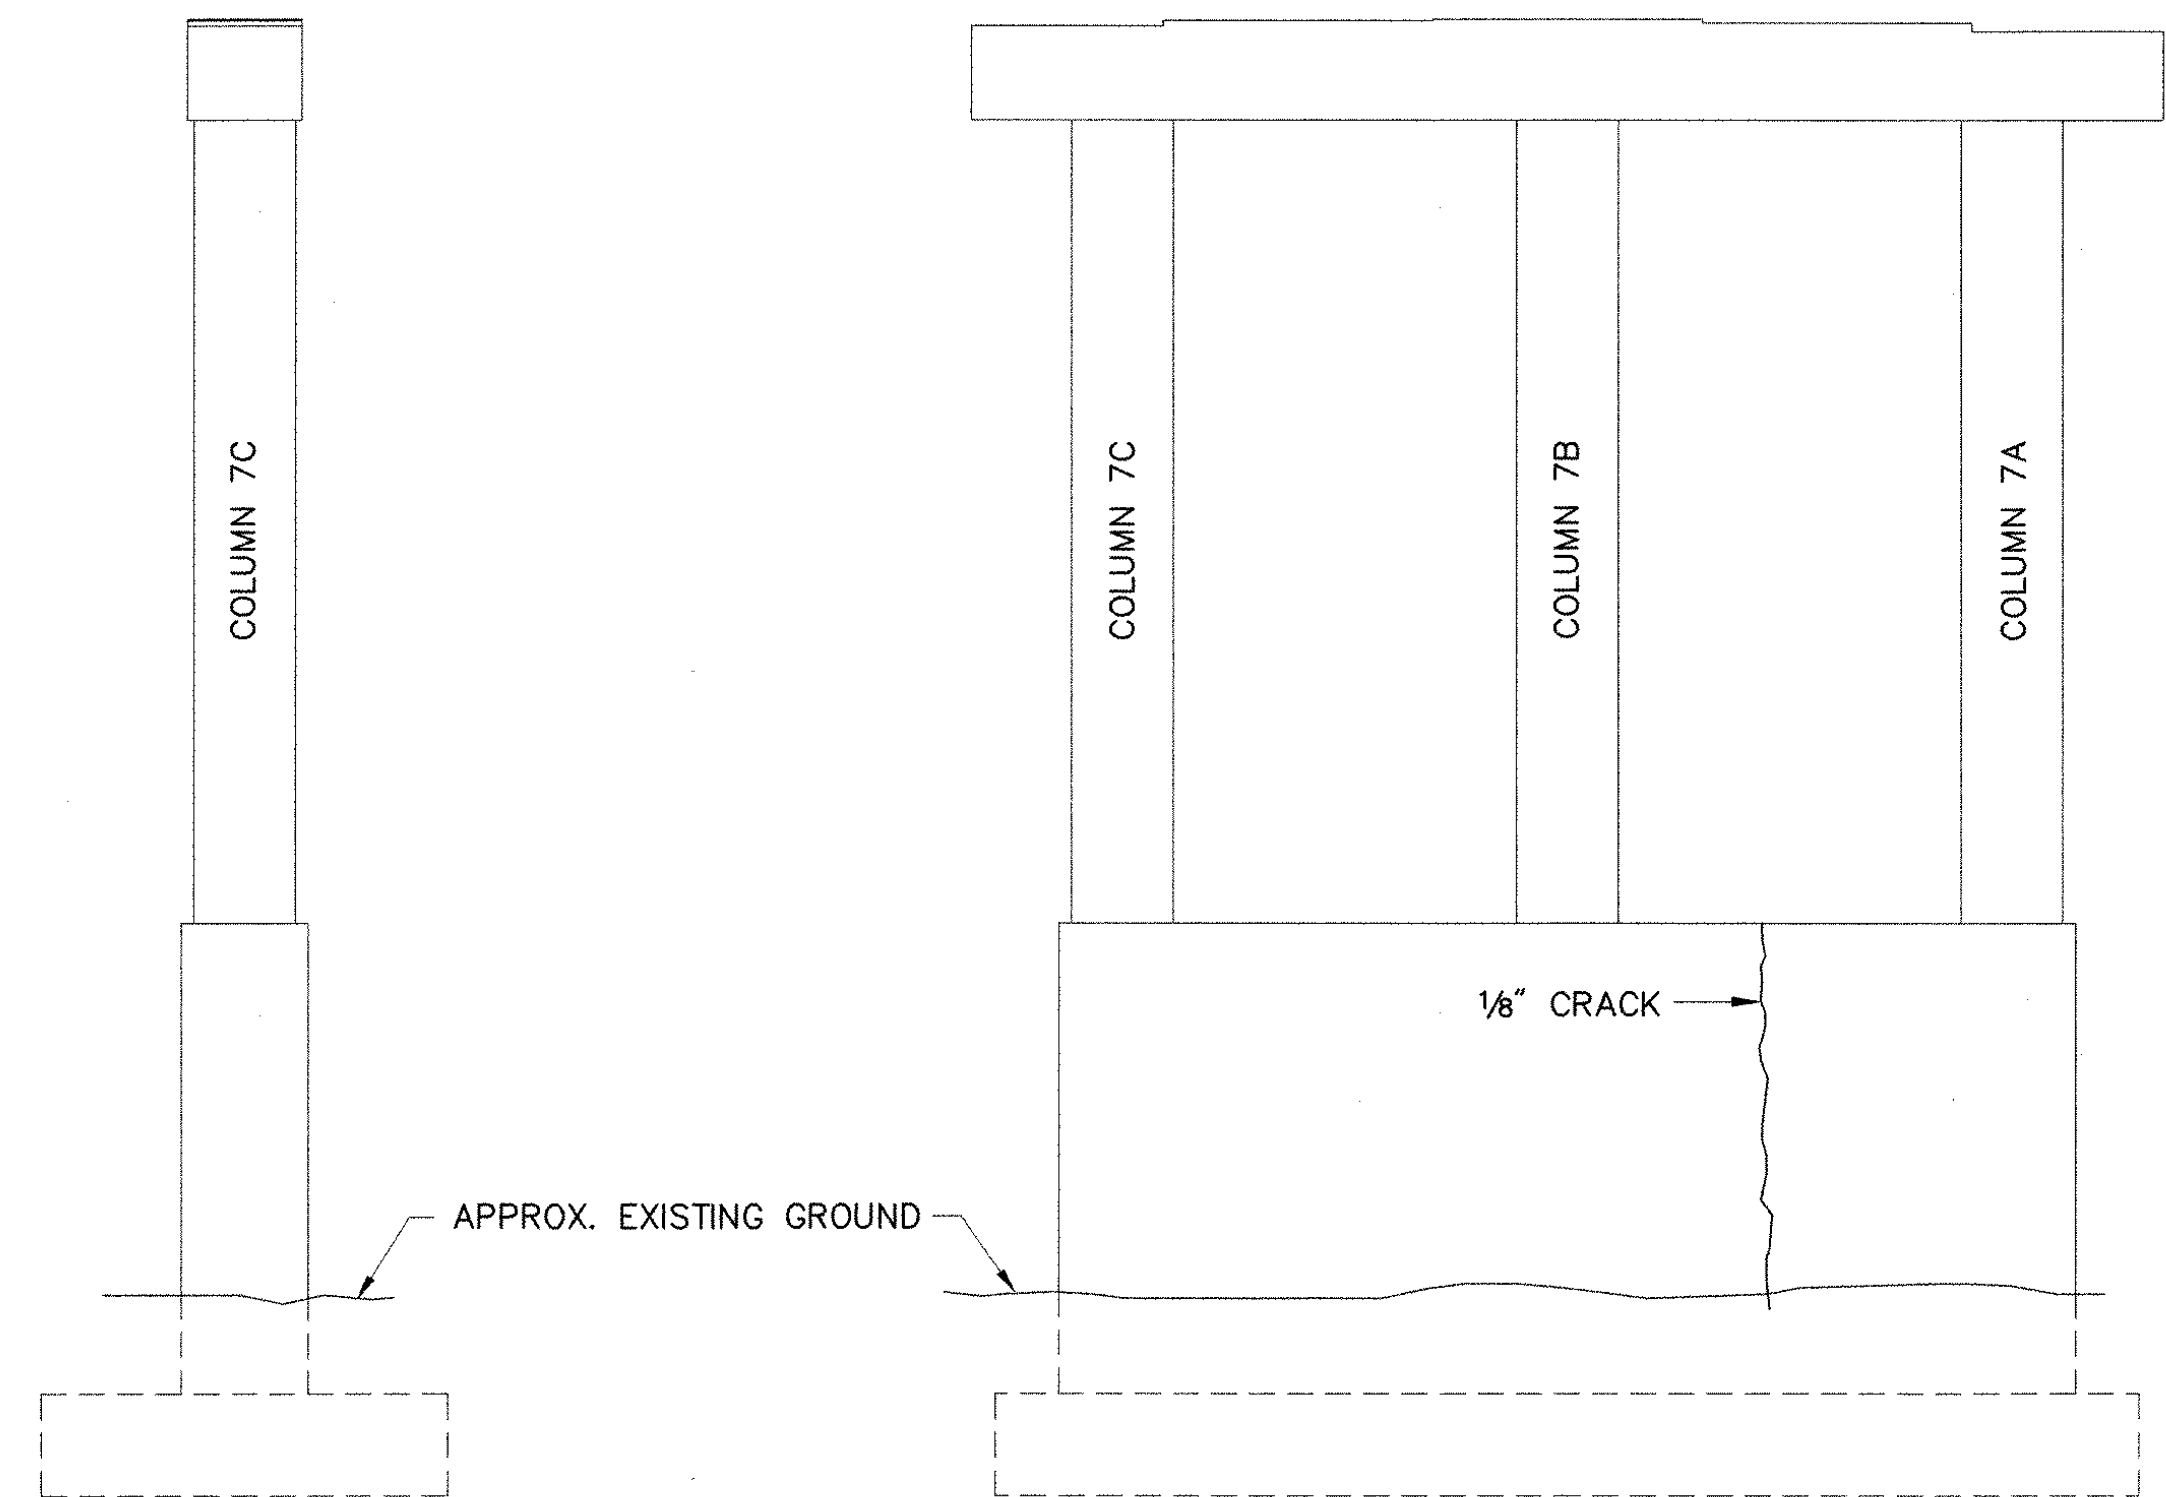

WEST END VIEW
SCALE: 1/8" = 1'-0"

SOUTH ELEVATION
SCALE: 1/8" = 1'-0"

KEY:

- DELAMINATED AREAS
- SPALLED AREAS

NOTES:

1. ONLY PIERS WITH DEFICIENCIES NOTED DURING THE INSPECTION ARE SHOWN.
2. SEE SHEET 22 FOR SUBSTRUCTURE CONCRETE REPAIR DETAILS.

STATE OF VERMONT AGENCY OF TRANSPORTATION			
Town Of HARTFORD		Bridge No. 11S	
Highway No. I-89 SB		Log Sta. Surv. Sta.	
I-89 SB OVER WHITE RIVER, VT 14 & NECR			
PIER 7 REPAIR AREAS			
Designed By T.S. BRYANT		Drawn By B.J. MASSE	
Checked By S.M. HODGDON	Date 9/98	Bridge Design Supervisor C.D. BAKER	Date 9/98
PROJECT HARTFORD		PROJECT NO. IR 089-1(13)	
VHB Cad Filename 50699P7		Sheet 38 of 101	
Bridge Sheet No. 38			

VANASSE HANGEN BRUSTLIN, INC.