



**PLAN**

SCALE: 1/8" = 1'-0"

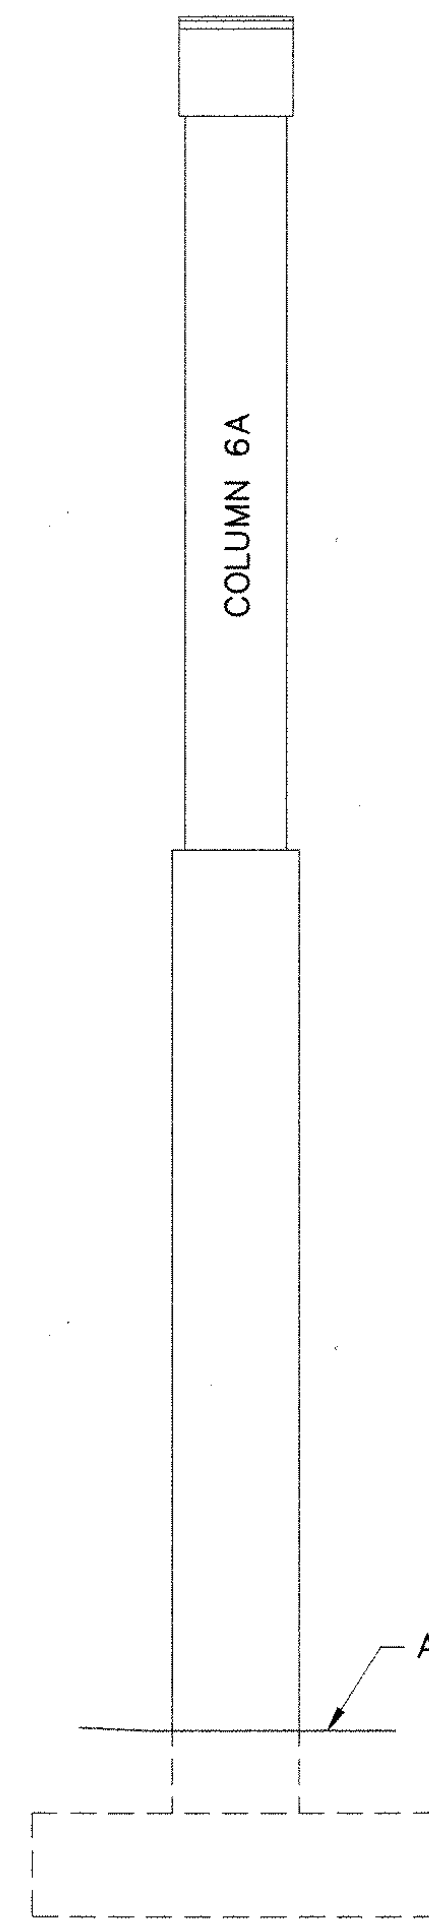


**EAST END VIEW**

SCALE: 1/8" = 1'-0"

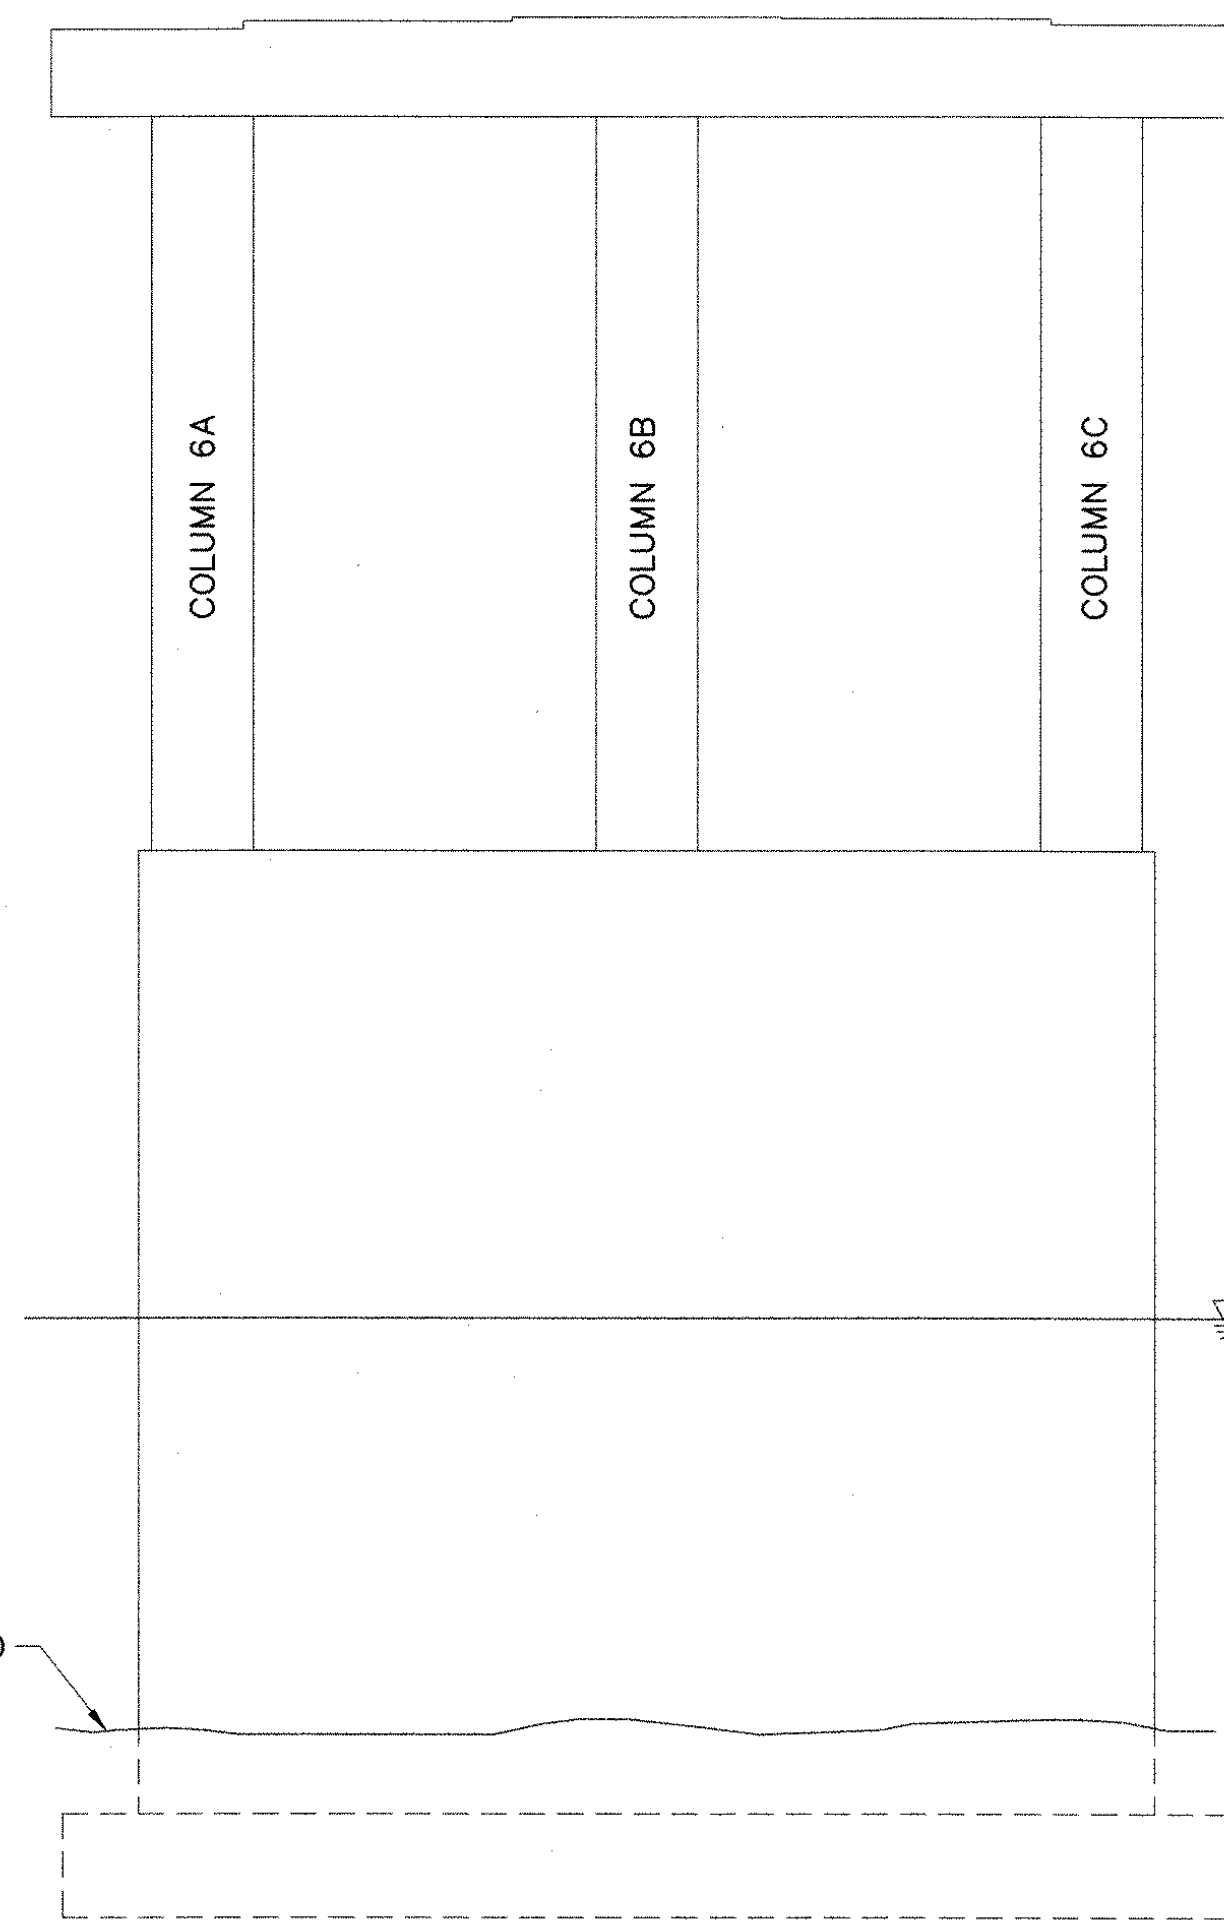


**NORTH ELEVATION**

SCALE: 1/8" = 1'-0"

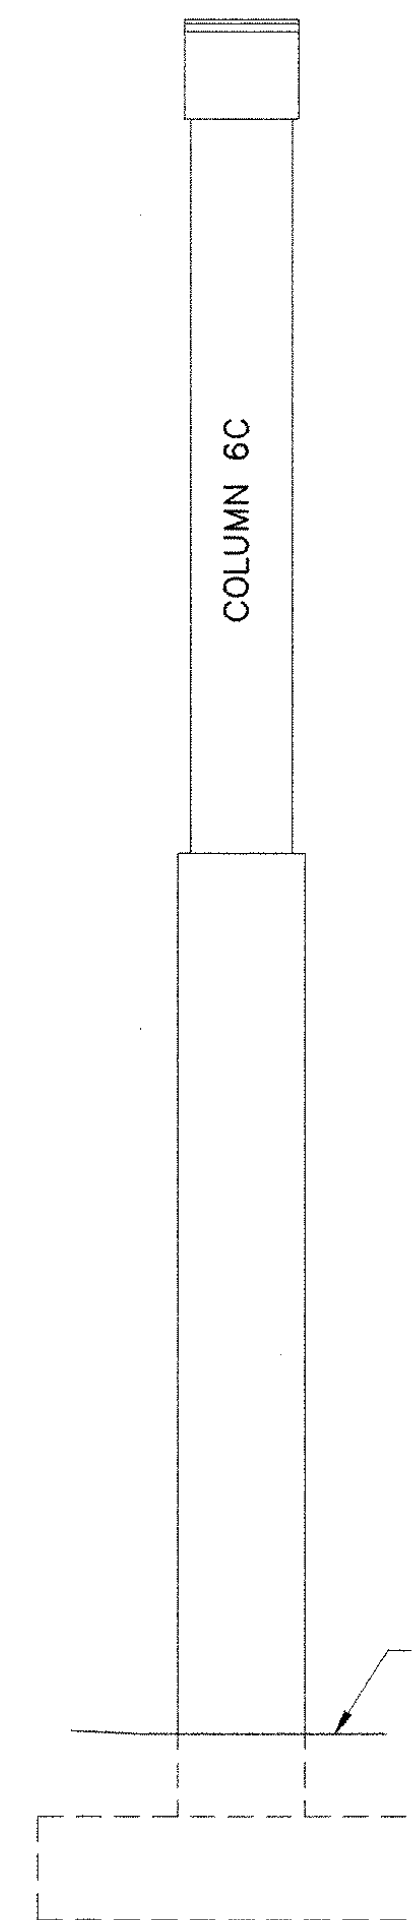

**EAST END VIEW**

SCALE: 1/8" = 1'-0"

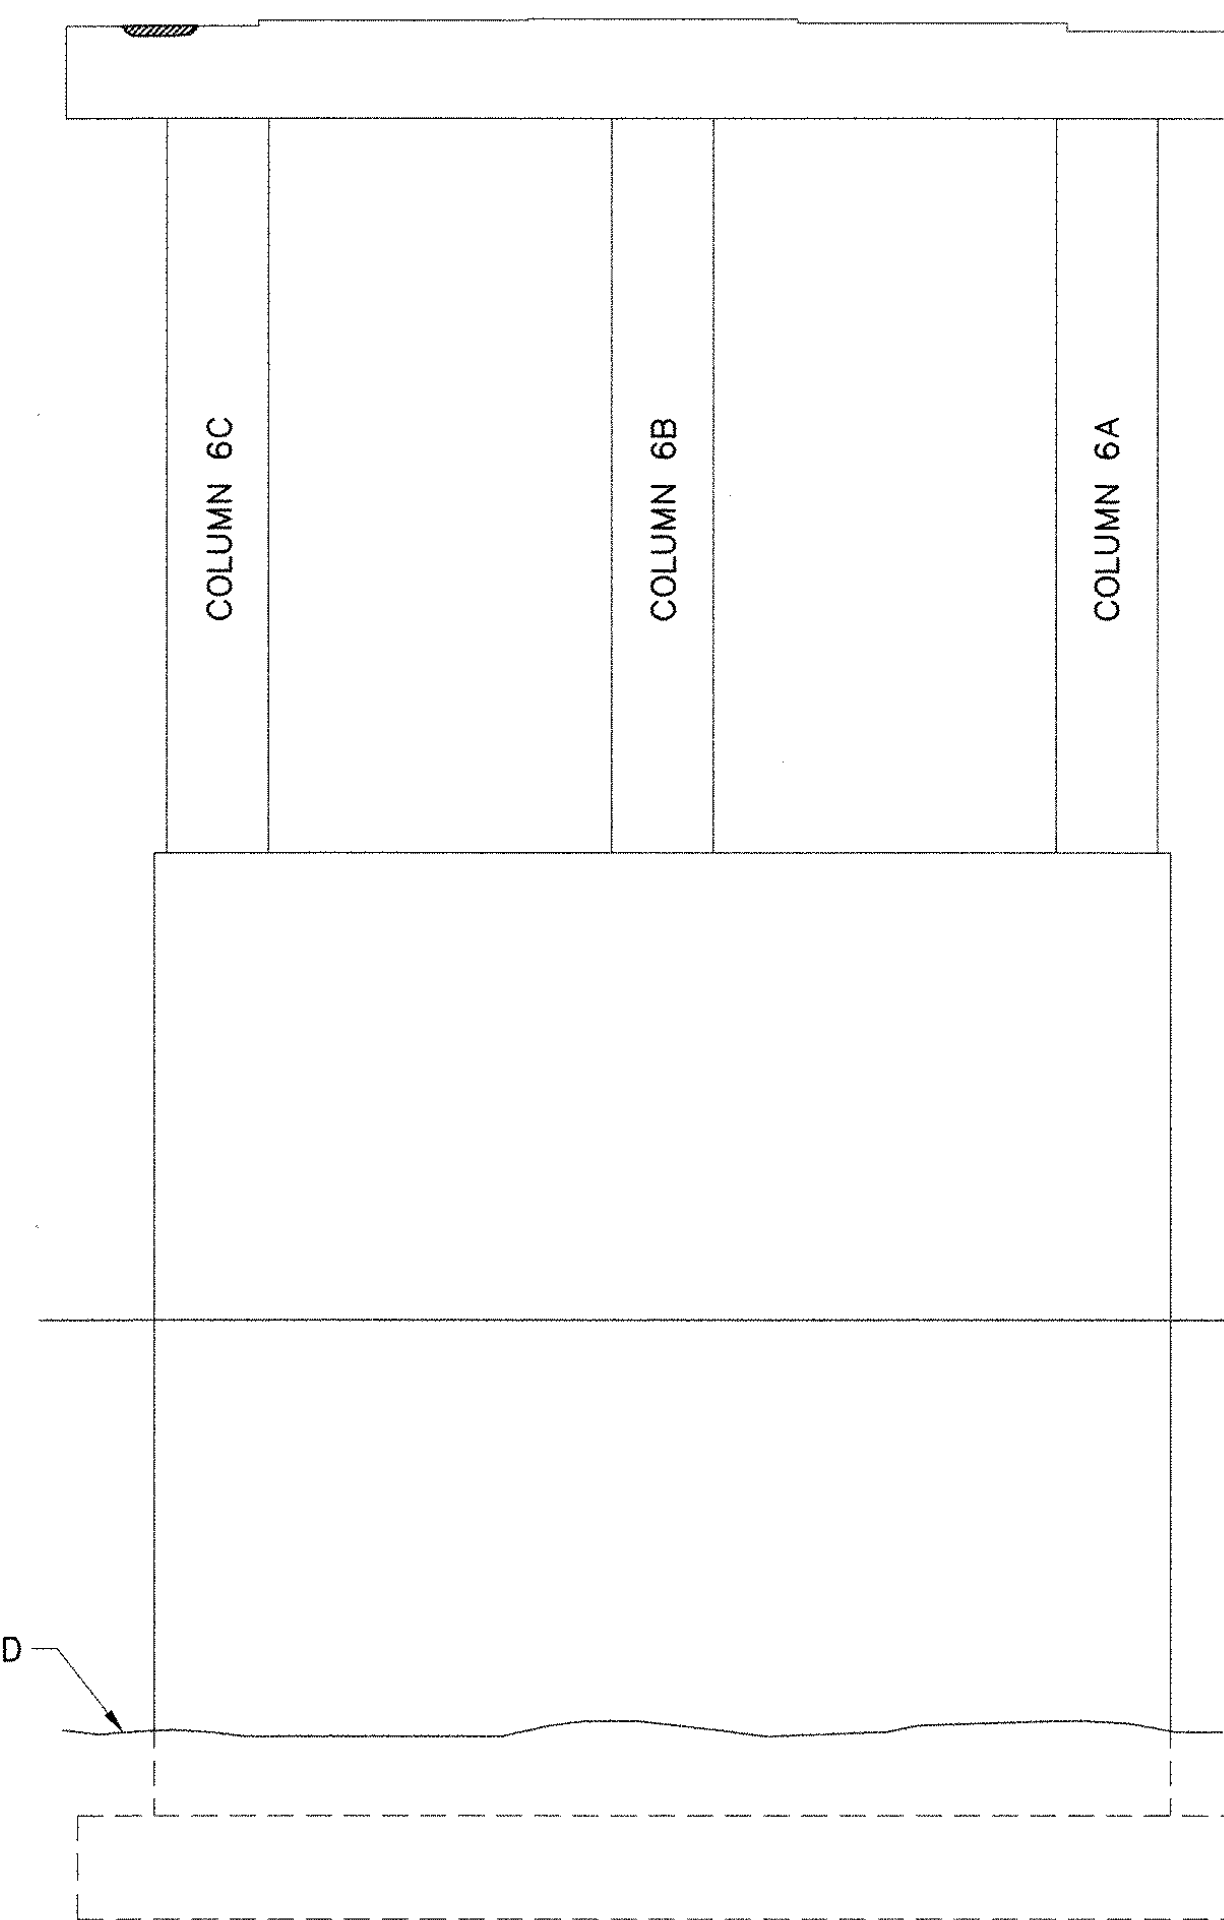

**SOUTH ELEVATION**

SCALE: 1/8" = 1'-0"

**KEY:**

- DELAMINATED AREAS
- SPALLED AREAS

**NOTES:**

1. ONLY PIERS WITH DEFICIENCIES NOTED DURING THE INSPECTION ARE SHOWN.
2. SEE SHEET 22 FOR SUBSTRUCTURE CONCRETE REPAIR DETAILS.

<b>STATE OF VERMONT AGENCY OF TRANSPORTATION</b>			
Town Of HARTFORD		Bridge No. 11N	
Highway No. 1-89 NB		Log Sta.	
		Surv. Sta.	
1-89 NB OVER WHITE RIVER, VT 14 & NECR			
<b>PIER 6 REPAIR AREAS</b>			
Designed By T.S. BRYANT		Drawn By B.J. MASSE	
Checked By S.M. HODGDON	Date 9/98	Bridge Design Supervisor C.D. BAKER	Date 9/98
PROJECT HARTFORD		PROJECT NO. IR 089-1(13)	
VHB Cad Filename 50699P6			
Bridge Sheet No. 37		Sheet 37 of 101	

VANASSE HANGEN BRUSTLIN, INC.