


BRIDGE 43N FRAMING PLAN
SCALE 1/8" = 1'-0"

NOTES:

1. *CVN DENOTES THAT CHARPY V-NOTCH TEST IS REQUIRED.
2. THE GIRDER BOTTOM FLANGE SHALL BE GRADE HPS 70W. ALL OTHER STEEL SHALL BE GRADE 50W.
3. PLACE DRIP PLATE ON LOW END OF EXTERIOR GIRDERS. SEE STRUCTURES DETAIL SD-601.00.
4. THE CONTRACTOR IS RESPONSIBLE FOR VERIFYING THE LOCATION OF THE BEARING STIFFENERS FOR THE LATERAL SLIDE SUPPORT.

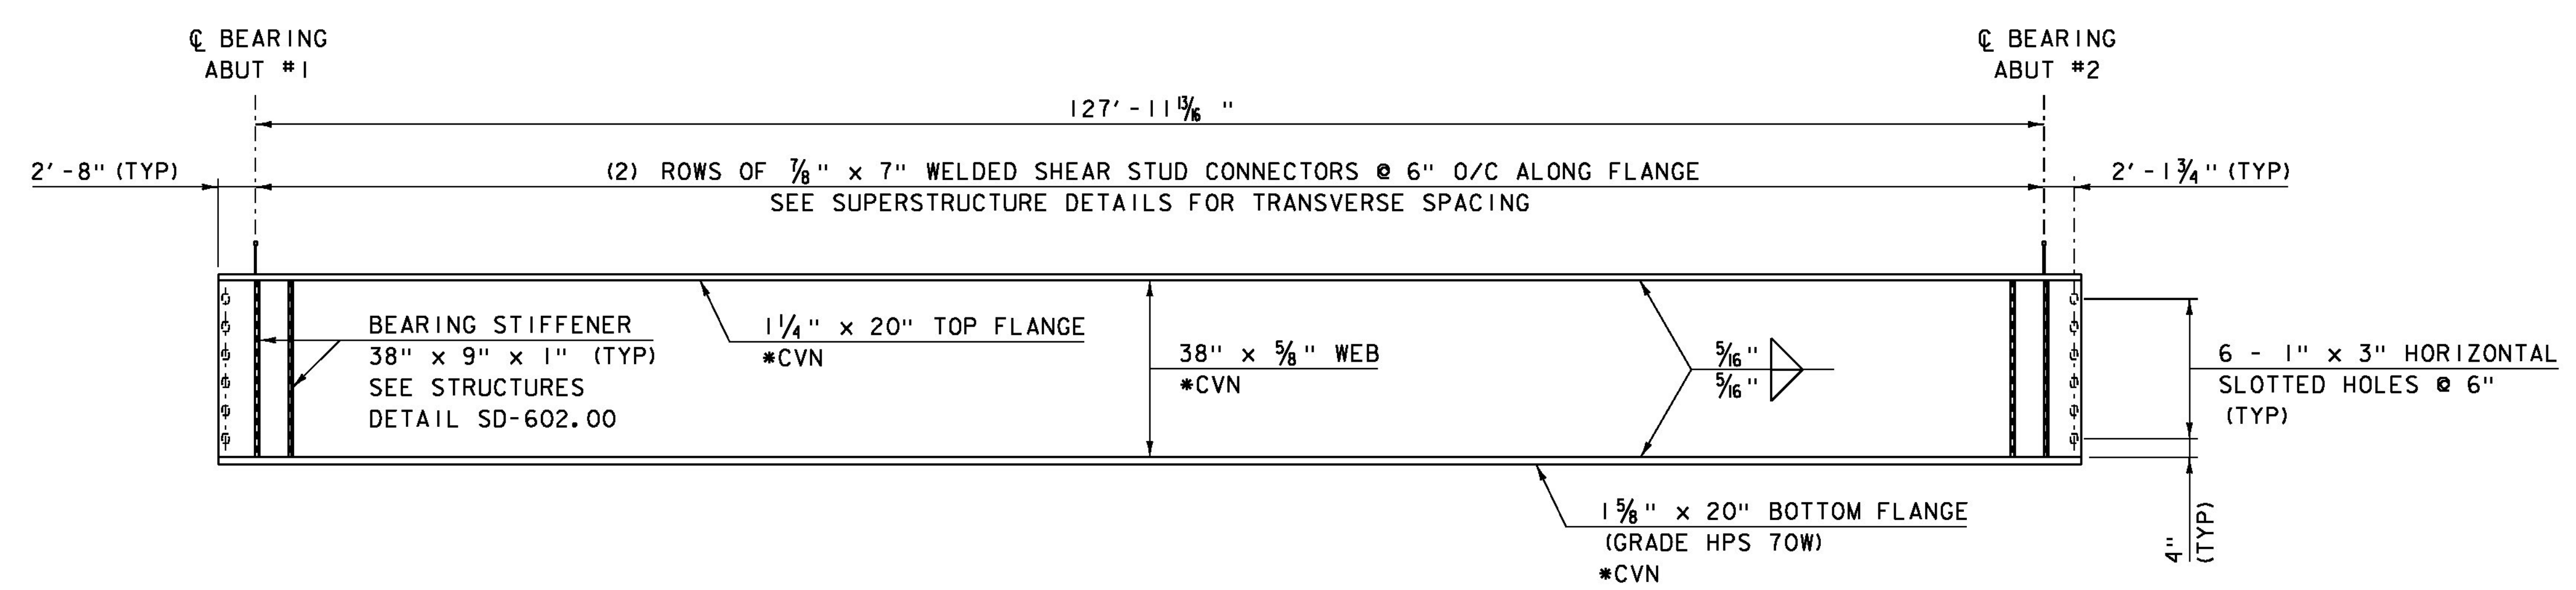

BRIDGE 43N TYPICAL GIRDER ELEVATION
HORIZONTAL SCALE 1/8" = 1'-0"
VERTICAL SCALE 1/2" = 1'-0"

PROJECT NAME:	HARTFORD	PLOT DATE:	15-DEC-2014
PROJECT NUMBER:	IM 091-2(79)	DRAWN BY:	R. KLINEFELTER
FILE NAME:	s12a132fr043N.dgn	DESIGNED BY:	R. KLINEFELTER
		CHECKED BY:	W. LAMMER
			BR 43N FRAMING PLAN & GIRDER ELEVATION SHEET 88 OF 166