


BRIDGE 43S FRAMING PLAN
SCALE 1/8" = 1'-0"

NOTES:

1. *CVN DENOTES THAT CHARPY V-NOTCH TEST IS REQUIRED.
2. ALL STEEL SHALL BE GRADE 50W.
3. PLACE DRIP PLATE ON LOW END OF EXTERIOR GIRDERS. SEE STRUCTURES DETAIL SD-601.00.
4. THE CONTRACTOR IS RESPONSIBLE FOR VERIFYING THE LOCATION OF THE BEARING STIFFENERS FOR THE LATERAL SLIDE SUPPORT.

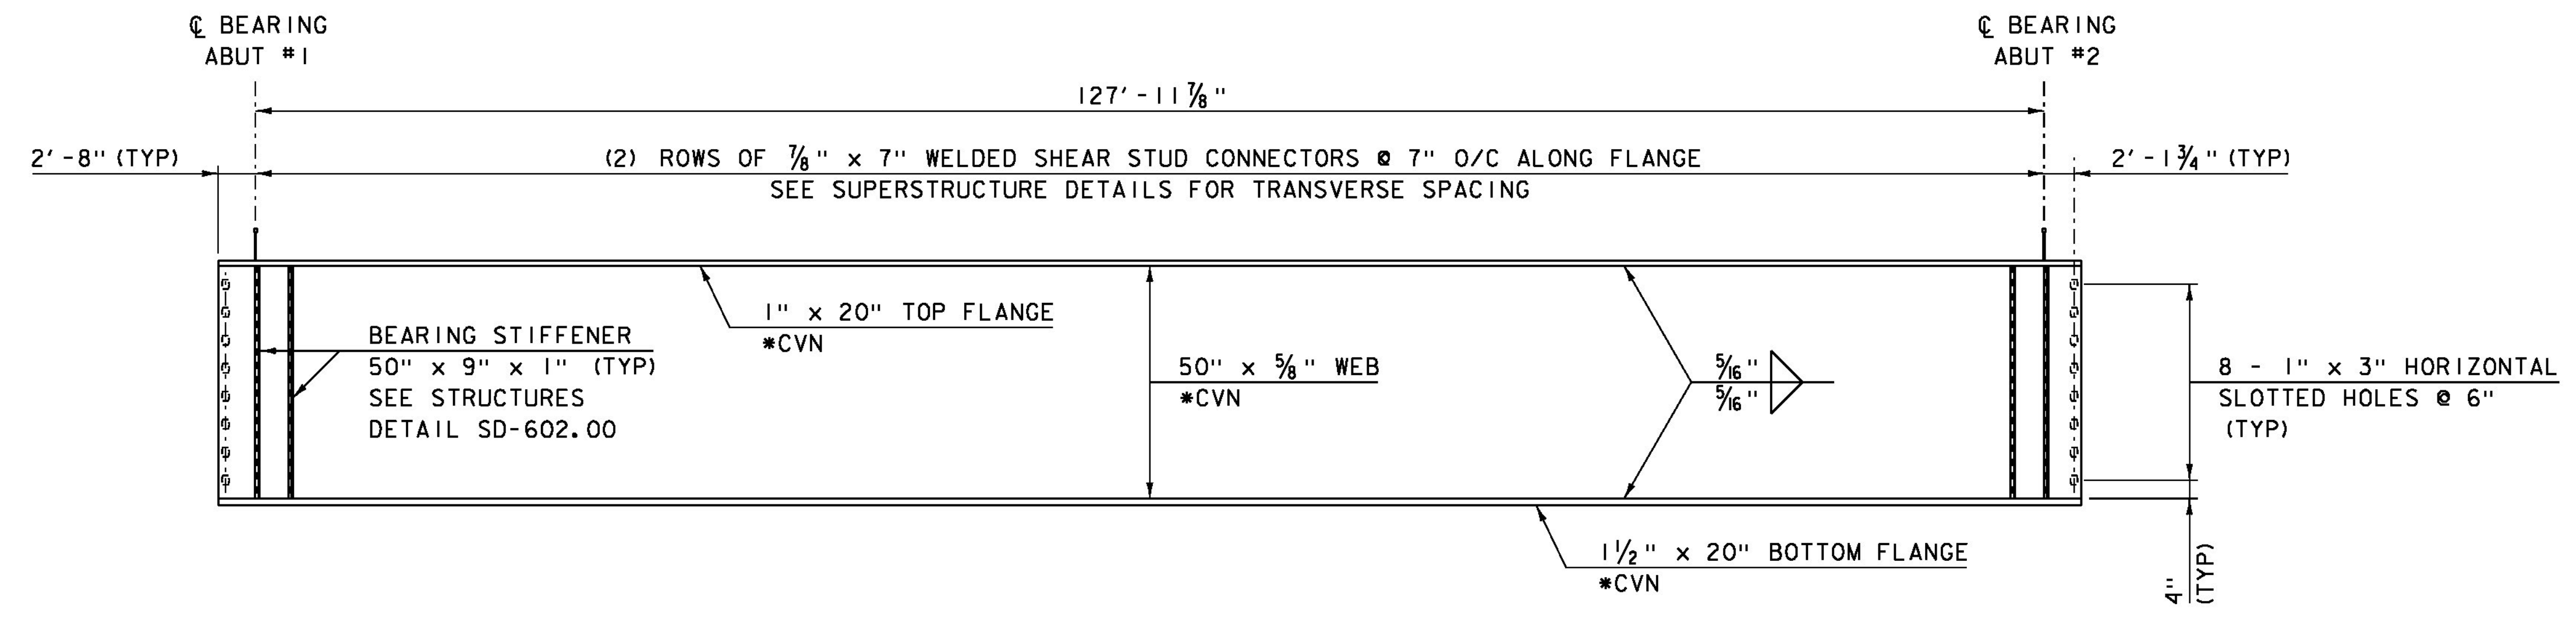

BRIDGE 43S TYPICAL GIRDER ELEVATION
HORIZONTAL SCALE 1/8" = 1'-0"
VERTICAL SCALE 1/2" = 1'-0"

PROJECT NAME: HARTFORD	PLOT DATE: 15-DEC-2014
PROJECT NUMBER: IM 09I-2(79)	DRAWN BY: R. KLINEFELTER
FILE NAME: s12a132fr-a43S.dgn	CHECKED BY: W. LAMMER
DESIGNED BY: R. KLINEFELTER	BR 43S FRAMING PLAN & GIRDER ELEVATION SHEET 87 OF 166