



STRUCTURE TABLE						
STRUCTURE	RIM	INV(S) IN	INV OUT	TYPE	NORTHING	EASTING
ST200A	914.33	912.94 (W) 912.94 (N)	912.69 (E)	4000 GAL. SEPTIC TANK	870825.09	1711816.75
S208	930.76	927.57 (SE)		8' I.D. EMERGENCY STORAGE MANHOLE	870260.94	1708739.29
S207	932.96	927.85 (NE) 927.85 (NE)	927.85 (SW) 927.85 (SW)	5' I.D. VALVE PIT	870240.01	1708745.23
S206	932.88	927.85 (NE) 927.85 (NE)	927.85 (SW) 927.85 (SW)	5' I.D. VALVE PIT	870244.22	1708740.95
S205	933.43	927.60 (NE)	927.85 (SW) 927.85 (SW) 927.85 (SW) 927.85 (SW) 927.60 (NW)	6' I.D.x12' I.D. PUMP STATION	870249.78	1708750.63
S204E	937.78	931.99 (NE)	931.99 (SW)	4' I.D. SEWER MANHOLE	870487.58	1708984.62
S204D	935.32	929.63 (NE)	929.63 (SW)	4' I.D. SEWER MANHOLE	870824.61	1709462.98
S204C	929.27	923.79 (E)	923.79 (W)	4' I.D. SEWER MANHOLE	870858.18	1710342.75
S204B	922.97	917.25 (E)	917.25 (W)	4' I.D. SEWER MANHOLE	871014.57	1711069.36
S204A	918.39	912.38 (E)	912.38 (W)	4' I.D. SEWER MANHOLE	871047.87	1711498.58
S204	916.49	910.32 (NE)	910.32 (SW)	5' I.D. VALVE PIT	871162.17	1711736.77
S203A	916.2	906.60 (W)	-	8' I.D. EMERGENCY STOP MANHOLE	-	-
S203	916.15	906.64 (S)	910.32 (SW) 906.64 (E)	8' I.D. PUMP STATION	871170.55	1711745.12
S203A	916.2	906.60 (W)	-	8' I.D. EMERGENCY STORAGE MANHOLE	871179.59	1711755.64
S202	915.77	908.99 (S)	908.89 (N)	4' I.D. SEWER MANHOLE	870960.01	1711824.48
S201	916.31	910.32 (W)	910.22 (N)	4' I.D. SEWER MANHOLE	870844.94	1711867.91
GI200	914.63	913.28 (NW)	913.04 (E)	3000 GAL GREASE INTERCEPTOR	870819.06	1711801.21

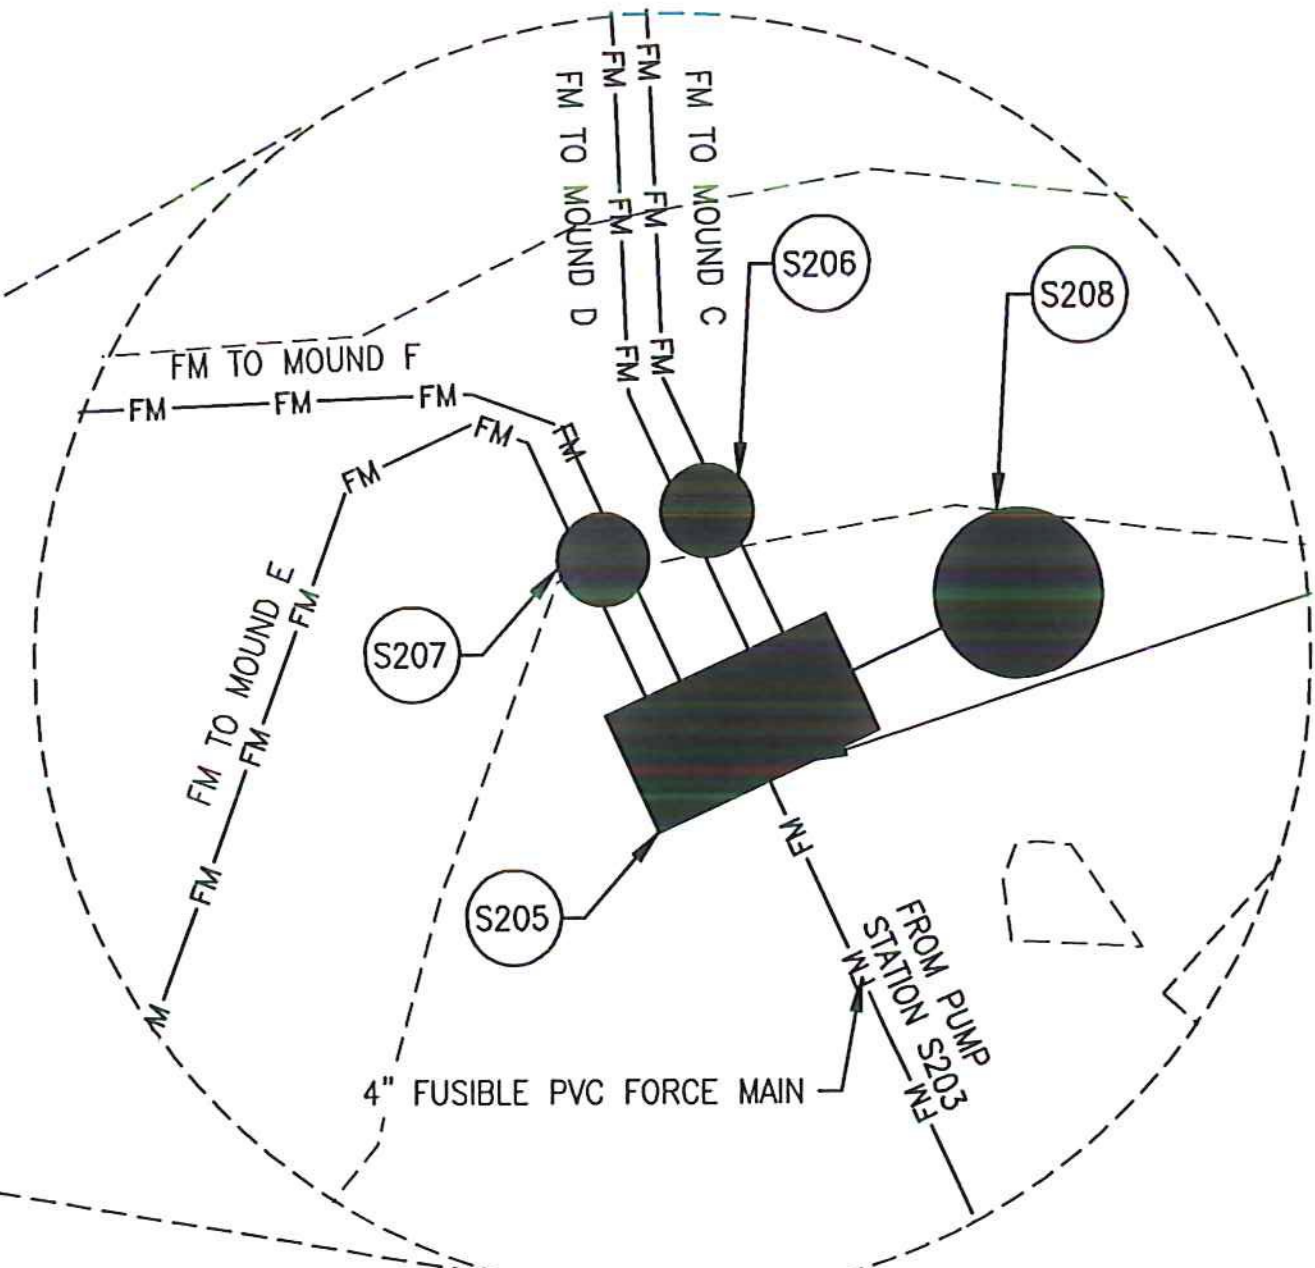

- LEGEND:**
- 950 --- EXISTING CONTOUR
 - 950 — PROPOSED CONTOUR
 - - - - - PROPERTY LINE
 - WETLAND
 - TREE LINE
 - FM — SANITARY FORCE MAIN
 - SANITARY MANHOLE
 - ST115 ○ S101 SANITARY STRUCTURE IDENTIFICATION


- NOTES:**
1. REFER TO SHEET PR2-03 FOR SITE 2 FORCE MAIN SEWER PROFILE.
 2. REFER TO SHEET MD2-01 FOR MOUND C & D DETAILS.
 3. REFER TO SHEET MD2-03 FOR MOUND F DETAILS

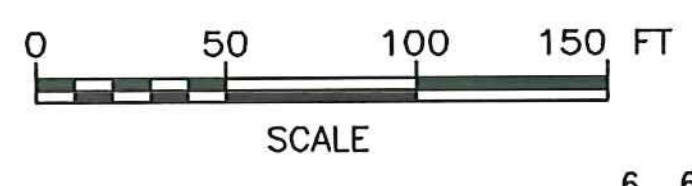

SCHEDULE B - WASTEWATER SYSTEM - BID SET
 VTRANS PROJECT #AV1157046-301
 JUNE 2016

IT IS A VIOLATION OF LAW FOR ANY PERSON, UNLESS THEY ARE ACTING UNDER THE DIRECT DIRECTION OF A LICENSED PROFESSIONAL ENGINEER, ARCHITECT, LANDSCAPE ARCHITECT, OR LAND SURVEYOR, TO ALTER AN ITEM IN ANY WAY. IF AN ITEM BEARING THE STAMP OF A LICENSED PROFESSIONAL IS ALTERED, THE ALTERING ENGINEER, ARCHITECT, LANDSCAPE ARCHITECT, OR LAND SURVEYOR SHALL STAMP THE DOCUMENT AND INCLUDE THE NOTATION "ALTERED BY" FOLLOWED BY THEIR SIGNATURE, THE DATE OF SUCH ALTERATION, AND A SPECIFIC DESCRIPTION OF THE ALTERATION.

REV	DATE	DESCRIPTION	BY
6	6/15/15	INSULATION CHANGES	BLS
5	5/3/15	COLD WEATHER MODIFICATIONS	BMB
4	4/29/15	PERMITTING MODIFICATIONS	SKI
3	1/30/15	WW SYSTEM MODIFICATIONS	BMB
2	8/5/14	ANR COMMENTS	TCB
1	4/18/14	ADD 400-SERIES TEST PITS	CH

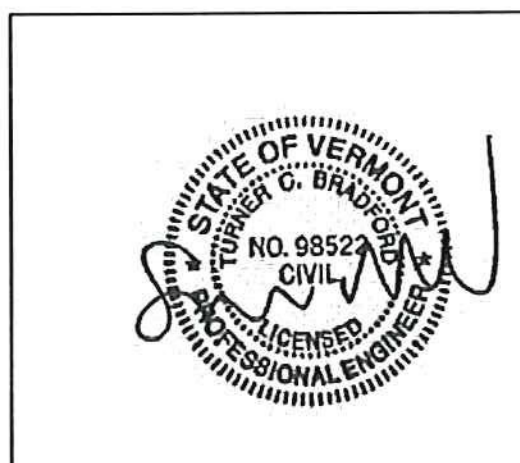

McFarland Johnson
 53 REGIONAL DRIVE
 CONCORD, NH 03301

NEWPORT STATE AIRPORT
 COVENTRY, VERMONT
 NEWPORT WASTEWATER
 SITE 2 - PIPING LAYOUT PLAN 5

SCALE: 1" = 50'	DESIGN: TCB	P2-05 24 OF 36
DRAWN: TCB	PROJECT: 17958.01	
CHECKED: BLS	DATE: JUNE, 2014	